Drawing List

ARCHITECTURAL

Pamela Ubeda Architect.AIBC
Coast + Beam Architecture
1387 St. David Street V8S 4Z2
778-587-4849
e: pamela@coastandbeam.com
w. coastandbeam.com

A100 Assemblies/Survey
A101 Site Plan/Zoning
A200 Foundation Plan
A201 Main Floor Plan
A202 Roof Plan
A300 Elevations
A400 Sections
A401 Sections
A500 Details

A501 Details
A600 Accessory Building
A800 3D Model

Highland Road Freeman / Van Mol Residence

- Development Permit Application

2023

September 12th

A R C H I T E C T U R E

1387 St. David Street V8S 4Z2

1387 St. David Street V8S 4Z2
778-587-4849
pamela@coastandbeam.com
coastandbeam.com

ABBREVIATIONS


| ACC. | |
|--|--|
| AUU. | ACCESSORY |
| @ | AT |
| & | AND |
| CL | CENTERLINE |
| PL | PROPERTY LINE |
| Ø | DIAMETER |
| 0 | DEGREES |
| " | FEET |
| A.F.F. | INCHES ABOVE FINISHED FLOOR |
| A.F.F. ALT. | ALTERNATE |
| ALUM. | ALUMINUM |
| ARCH. | ARCHITECTURAL |
| B.O. | BOTTOM OF |
| B.O.W. | BOTTOM OF WALL |
| C.I.P. | CAST-IN-PLACE |
| CLG. | CEILING |
| CONC. | CONCRETE |
| C.M.U. | CONCRETE MASONRY UNIT |
| CONT. | CONTINUOUS |
| DIM. DN | DIMENSION Down |
| DWG. | DRAWING |
| E E | EAST |
| EA. | EACH |
| EL. | ELEVATION |
| ELEC. | ELECTRICAL |
| EQ. | EQUAL |
| EQUIP. | EQUIPMENT |
| EXIST. | EXISTING |
| EXT. | EXTERIOR |
| F.F. FIN. | FINISHED FLOOR FINISH |
| F.O. | FACE OF |
| F.O.C. | FACE OF CONCRETE |
| F.O.F. | FACE OF FINISH |
| F.O.I.C. | FACE OF STUD |
| FT | FEET |
| G.W.B. | GYPSUM WALL BOARD |
| H.V.A.C. | HEATING / VENTILATION / AIR CONDITIONING |
| HA | HECTARES |
| H.B. I.D. | HOSE BIBB Inside Diameter |
| I.D. | INCH |
| INT. | INTERIOR |
| M | METERS |
| MANUF. | MANUFACTURER |
| MAX. | MAXIMUM |
| MECH. | MECHANICAL |
| MIN. | MINIMUM |
| MM MTL. | MILLIMETERS METAL |
| N N | NORTH |
| NO. | NOMITI |
| | NUMBER |
| N.T.S. | NUMBER NOT TO SCALE |
| | |
| N.T.S. | NOT TO SCALE |
| N.T.S. O.C. O.D. OPP. | NOT TO SCALE ON CENTER OUTSIDE DIAMETER OPPOSITE |
| N.T.S. O.C. O.D. OPP. PLUMB. | NOT TO SCALE ON CENTER OUTSIDE DIAMETER OPPOSITE PLUMBING |
| N.T.S. O.C. O.D. OPP. PLUMB. R | NOT TO SCALE ON CENTER OUTSIDE DIAMETER OPPOSITE PLUMBING RISER |
| N.T.S. O.C. O.D. OPP. PLUMB. R R.C.P. | NOT TO SCALE ON CENTER OUTSIDE DIAMETER OPPOSITE PLUMBING RISER REFLECTED CEILING PLAN |
| N.T.S. O.C. O.D. OPP. PLUMB. R R.C.P. REQ. | NOT TO SCALE ON CENTER OUTSIDE DIAMETER OPPOSITE PLUMBING RISER REFLECTED CEILING PLAN REQUIRED |
| N.T.S. O.C. O.D. OPP. PLUMB. R R.C.P. | NOT TO SCALE ON CENTER OUTSIDE DIAMETER OPPOSITE PLUMBING RISER REFLECTED CEILING PLAN |
| N.T.S. O.C. O.D. OPP. PLUMB. R R.C.P. REQ. REV. | NOT TO SCALE ON CENTER OUTSIDE DIAMETER OPPOSITE PLUMBING RISER REFLECTED CEILING PLAN REQUIRED REVISION |
| N.T.S. O.C. O.D. OPP. PLUMB. R R.C.P. REQ. REV. S | NOT TO SCALE ON CENTER OUTSIDE DIAMETER OPPOSITE PLUMBING RISER REFLECTED CEILING PLAN REQUIRED REVISION SOUTH |
| N.T.S. O.C. O.D. OPP. PLUMB. R R.C.P. REQ. REV. S S.A.F. | NOT TO SCALE ON CENTER OUTSIDE DIAMETER OPPOSITE PLUMBING RISER REFLECTED CEILING PLAN REQUIRED REVISION SOUTH SELF-ADHERED FLASHING SIMILAR SPECIFICATION |
| N.T.S. O.C. O.D. OPP. PLUMB. R R.C.P. REQ. REV. S S.A.F. SIM. SPEC. | NOT TO SCALE ON CENTER OUTSIDE DIAMETER OPPOSITE PLUMBING RISER REFLECTED CEILING PLAN REQUIRED REVISION SOUTH SELF-ADHERED FLASHING SIMILAR SPECIFICATION SQUARE FEET |
| N.T.S. O.C. O.D. OPP. PLUMB. R R.C.P. REQ. REV. S S.A.F. SIM. SPEC. sf m ² | NOT TO SCALE ON CENTER OUTSIDE DIAMETER OPPOSITE PLUMBING RISER REFLECTED CEILING PLAN REQUIRED REVISION SOUTH SELF-ADHERED FLASHING SIMILAR SPECIFICATION SQUARE FEET SQUARE METERS |
| N.T.S. O.C. O.D. OPP. PLUMB. R R.C.P. REQ. REV. S S.A.F. SIM. SPEC. sf m² STRUCT. | NOT TO SCALE ON CENTER OUTSIDE DIAMETER OPPOSITE PLUMBING RISER REFLECTED CEILING PLAN REQUIRED REVISION SOUTH SELF-ADHERED FLASHING SIMILAR SPECIFICATION SQUARE FEET SQUARE METERS STRUCTURAL |
| N.T.S. O.C. O.D. OPP. PLUMB. R R.C.P. REQ. REV. S S.A.F. SIM. SPEC. sf m² STRUCT. T&G | NOT TO SCALE ON CENTER OUTSIDE DIAMETER OPPOSITE PLUMBING RISER REFLECTED CEILING PLAN REQUIRED REVISION SOUTH SELF-ADHERED FLASHING SIMILAR SPECIFICATION SQUARE FEET SQUARE METERS STRUCTURAL TONGUE AND GROOVE |
| N.T.S. O.C. O.D. OPP. PLUMB. R R.C.P. REQ. REV. S S.A.F. SIM. SPEC. sf m² STRUCT. T&G T.O. | NOT TO SCALE ON CENTER OUTSIDE DIAMETER OPPOSITE PLUMBING RISER REFLECTED CEILING PLAN REQUIRED REVISION SOUTH SELF-ADHERED FLASHING SIMILAR SPECIFICATION SQUARE FEET SQUARE METERS STRUCTURAL |
| N.T.S. O.C. O.D. OPP. PLUMB. R R.C.P. REQ. REV. S S.A.F. SIM. SPEC. sf m² STRUCT. T&G | NOT TO SCALE ON CENTER OUTSIDE DIAMETER OPPOSITE PLUMBING RISER REFLECTED CEILING PLAN REQUIRED REVISION SOUTH SELF-ADHERED FLASHING SIMILAR SPECIFICATION SQUARE FEET SQUARE METERS STRUCTURAL TONGUE AND GROOVE TOP OF |
| N.T.S. O.C. O.D. OPP. PLUMB. R R.C.P. REQ. REV. S S.A.F. SIM. SPEC. sf m² STRUCT. T&G T.O. T.O.P. | NOT TO SCALE ON CENTER OUTSIDE DIAMETER OPPOSITE PLUMBING RISER REFLECTED CEILING PLAN REQUIRED REVISION SOUTH SELF-ADHERED FLASHING SIMILAR SPECIFICATION SQUARE FEET SQUARE METERS STRUCTURAL TONGUE AND GROOVE TOP OF PAVEMENT |
| N.T.S. O.C. O.D. OPP. PLUMB. R R.C.P. REQ. REV. S S.A.F. SIM. SPEC. sf m² STRUCT. T&G T.O. T.O.P. T.O.S. | NOT TO SCALE ON CENTER OUTSIDE DIAMETER OPPOSITE PLUMBING RISER REFLECTED CEILING PLAN REQUIRED REVISION SOUTH SELF-ADHERED FLASHING SIMILAR SPECIFICATION SQUARE FEET SQUARE METERS STRUCTURAL TONGUE AND GROOVE TOP OF PAVEMENT TOP OF SLAB |
| N.T.S. O.C. O.D. OPP. PLUMB. R R.C.P. REQ. REV. S S.A.F. SIM. SPEC. sf m² STRUCT. T&G T.O. T.O.P. T.O.S. T.O.W. TYP. U.N.O. | NOT TO SCALE ON CENTER OUTSIDE DIAMETER OPPOSITE PLUMBING RISER REFLECTED CEILING PLAN REQUIRED REVISION SOUTH SELF-ADHERED FLASHING SIMILAR SPECIFICATION SQUARE FEET SQUARE METERS STRUCTURAL TONGUE AND GROOVE TOP OF TOP OF PAVEMENT TOP OF SLAB TOP OF WALL TYPICAL UNLESS NOTED OTHERWISE |
| N.T.S. O.C. O.D. OPP. PLUMB. R R.C.P. REQ. REV. S S.A.F. SIM. SPEC. sf m² STRUCT. T&G T.O. T.O.P. T.O.S. T.O.W. TYP. U.N.O. V.I.F. | NOT TO SCALE ON CENTER OUTSIDE DIAMETER OPPOSITE PLUMBING RISER REFLECTED CEILING PLAN REQUIRED REVISION SOUTH SELF-ADHERED FLASHING SIMILAR SPECIFICATION SQUARE FEET SQUARE METERS STRUCTURAL TONGUE AND GROOVE TOP OF TOP OF PAVEMENT TOP OF SLAB TOP OF WALL TYPICAL UNLESS NOTED OTHERWISE VERIFY IN FIELD |
| N.T.S. O.C. O.D. OPP. PLUMB. R R.C.P. REQ. REV. S S.A.F. SIM. SPEC. sf m² STRUCT. T&G T.O. T.O.P. T.O.S. T.O.W. TYP. U.N.O. V.I.F. V.W.M. | NOT TO SCALE ON CENTER OUTSIDE DIAMETER OPPOSITE PLUMBING RISER REFLECTED CEILING PLAN REQUIRED REVISION SOUTH SELF-ADHERED FLASHING SIMILAR SPECIFICATION SQUARE FEET SQUARE METERS STRUCTURAL TONGUE AND GROOVE TOP OF TOP OF PAVEMENT TOP OF SLAB TOP OF WALL TYPICAL UNLESS NOTED OTHERWISE VERIFY IN FIELD VERIFY WITH MANUFACTURER |
| N.T.S. O.C. O.D. OPP. PLUMB. R R.C.P. REQ. REV. S S.A.F. SIM. SPEC. sf m² STRUCT. T&G T.O. T.O.P. T.O.S. T.O.W. TYP. U.N.O. V.I.F. V.W.M. W | NOT TO SCALE ON CENTER OUTSIDE DIAMETER OPPOSITE PLUMBING RISER REFLECTED CEILING PLAN REQUIRED REVISION SOUTH SELF-ADHERED FLASHING SIMILAR SPECIFICATION SQUARE FEET SQUARE METERS STRUCTURAL TONGUE AND GROOVE TOP OF TOP OF PAVEMENT TOP OF SLAB TOP OF WALL TYPICAL UNLESS NOTED OTHERWISE VERIFY WITH MANUFACTURER WEST |
| N.T.S. O.C. O.D. OPP. PLUMB. R R.C.P. REQ. REV. S S.A.F. SIM. SPEC. sf m² STRUCT. T&G T.O. T.O.P. T.O.S. T.O.W. TYP. U.N.O. V.I.F. V.W.M. | NOT TO SCALE ON CENTER OUTSIDE DIAMETER OPPOSITE PLUMBING RISER REFLECTED CEILING PLAN REQUIRED REVISION SOUTH SELF-ADHERED FLASHING SIMILAR SPECIFICATION SQUARE FEET SQUARE METERS STRUCTURAL TONGUE AND GROOVE TOP OF TOP OF PAVEMENT TOP OF SLAB TOP OF WALL TYPICAL UNLESS NOTED OTHERWISE VERIFY IN FIELD VERIFY WITH MANUFACTURER |


WOOD


X.P.S.

WATERPROOF

EXTRUDED POLYSTYRENE

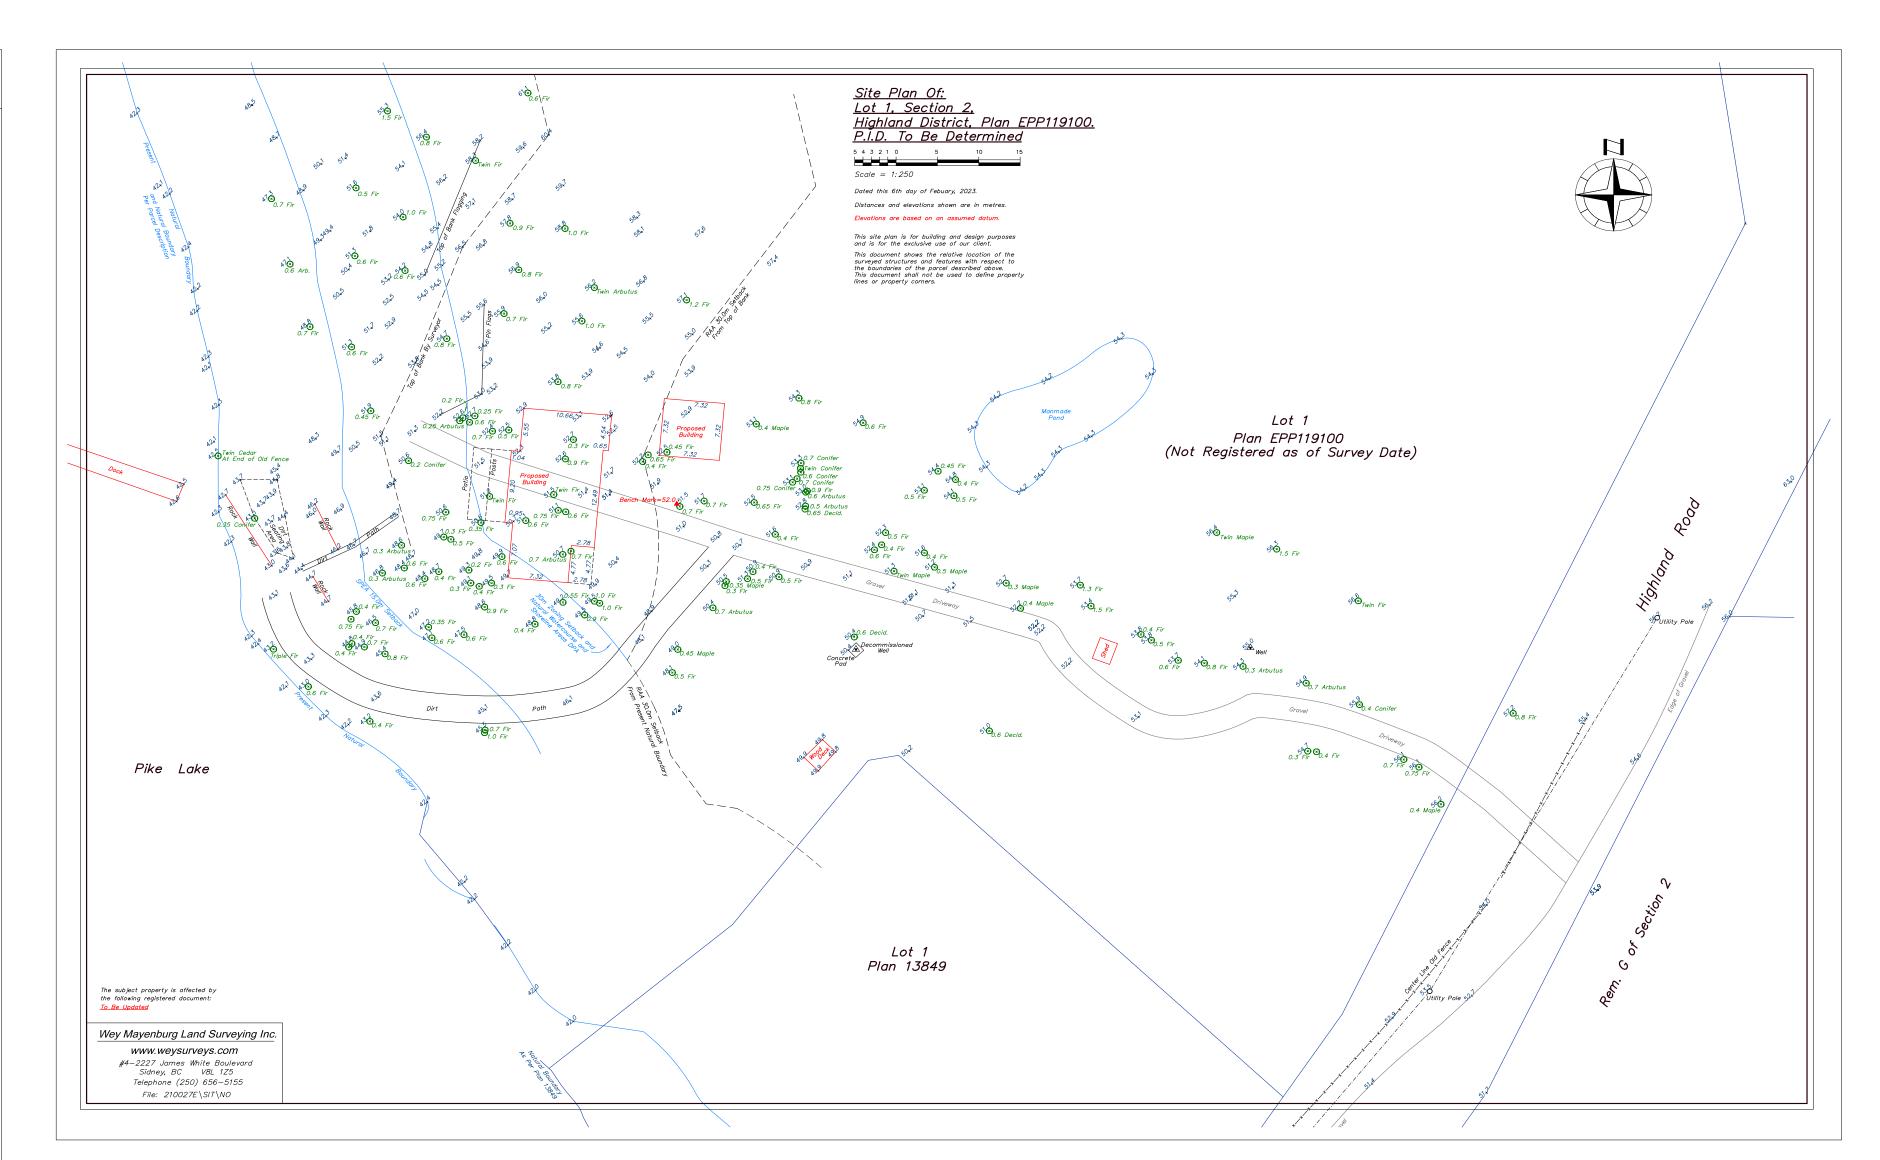

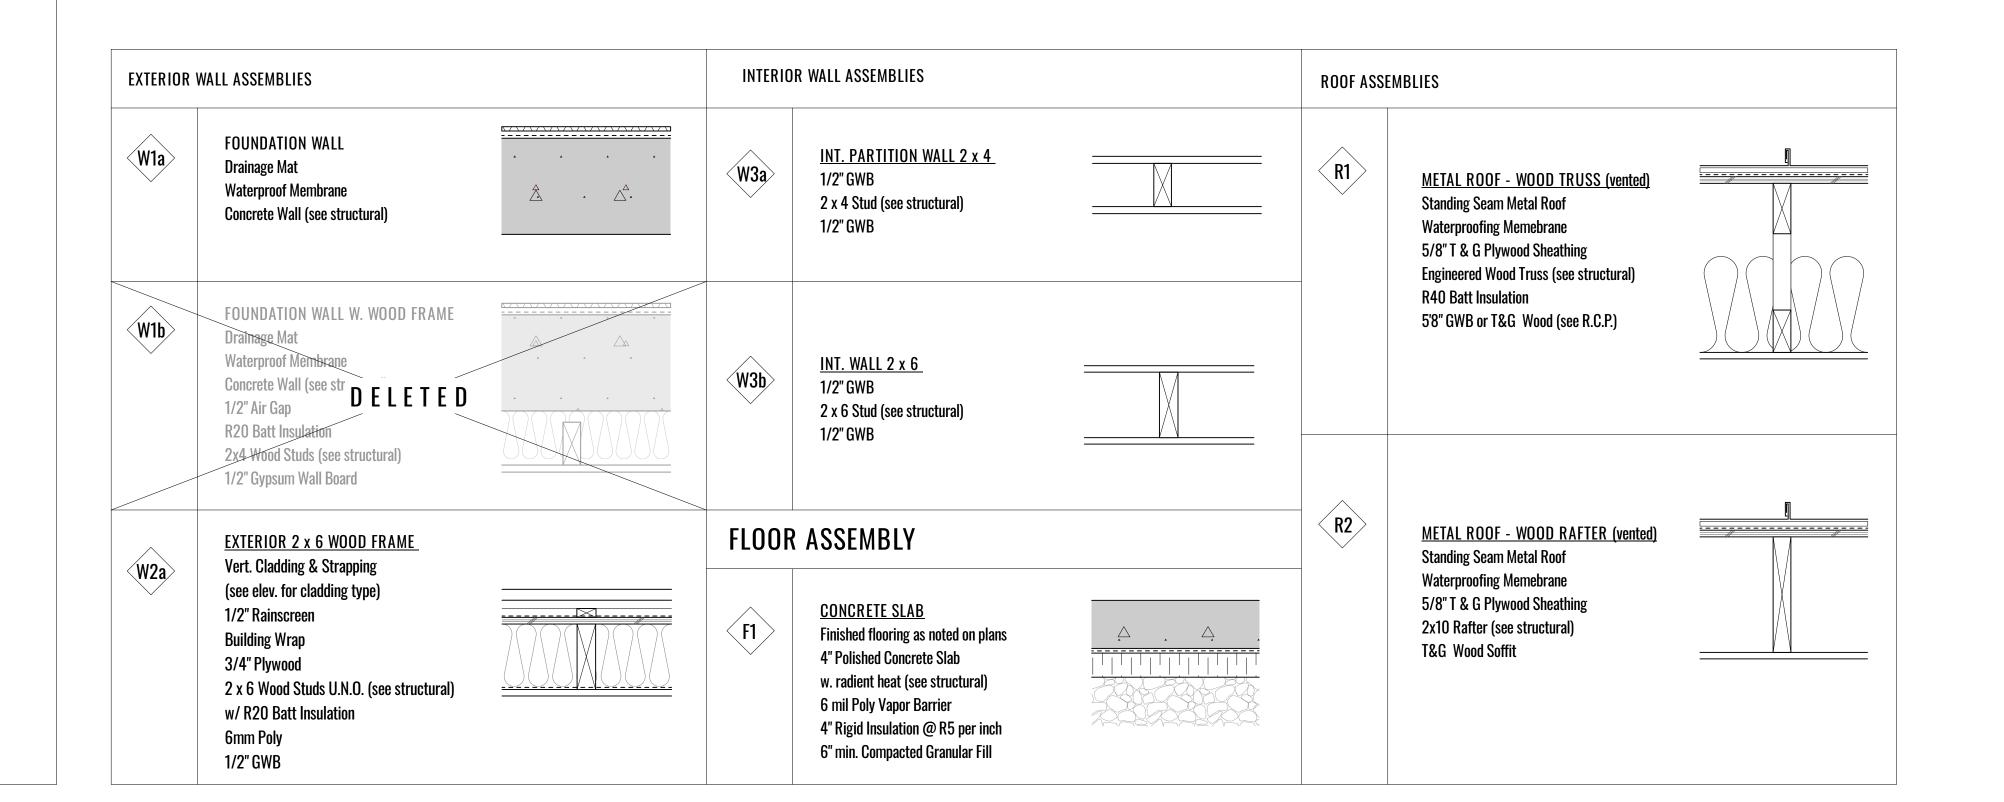

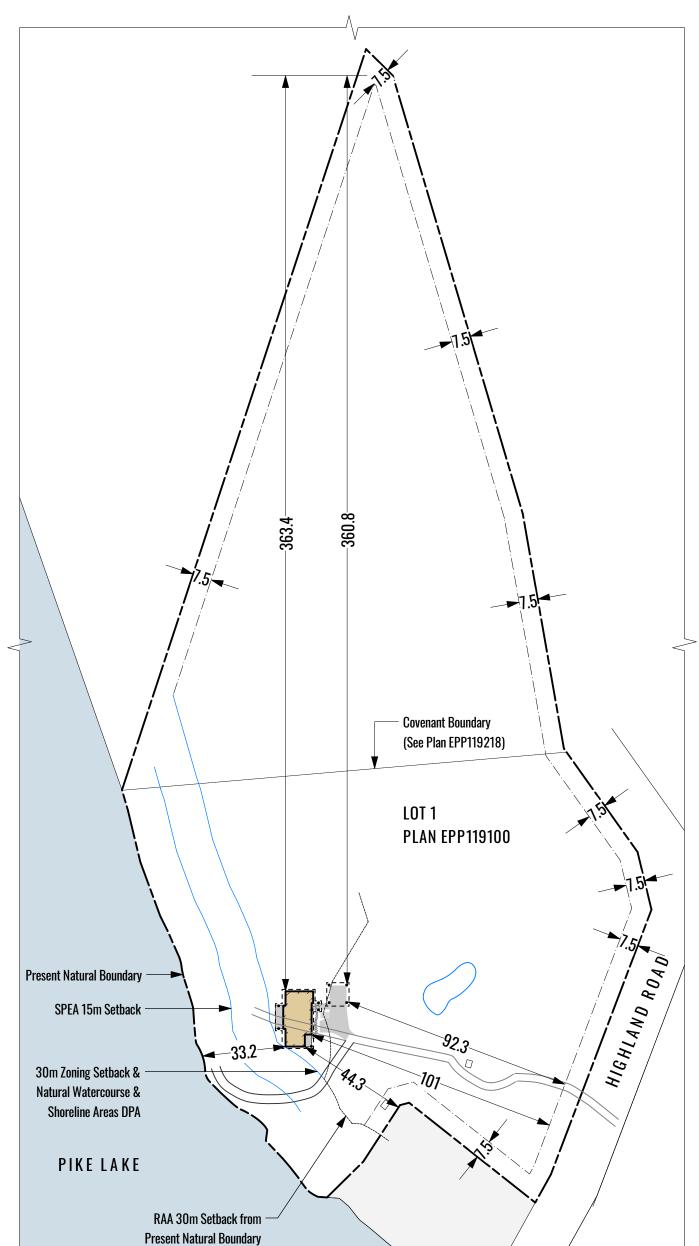



GENERAL NOTES

CONSTRUCTION

ALL RIGHTS OF WAY BOUNDARIES, SETBACKS AND PROPERTY LINES TO BE CONFIRMED BY B.C.L.S. PRIOR TO

CONTRACTOR TO VERIFY ALL DIMENSIONS AND CONFIRM

ANY INCONSISTENCIES OR UNFORESEEN CONDITIONS TO BE REVIEWED BY THE ARCHITECT PRIOR TO PROCEEDING WITH

ALL CLEARANCES, METHODS AND MATERIALS TO BE COMPLIANT TO ALL APPLICABLE BUILDING CODES AND

MUNICIPAL BYLAWS SITE SURVEY PROVIDED BY SUMMIT LAND SURVEYING INC.

ALL DIMENSIONS ARE IN FEET AND INCHES UNLESS OTHERWISE NOTED

DO NOT SCALE DRAWINGS

ALL DIMENSIONS ARE MEASURED TO FACE OF STRUCTURE, UNLESS NOTED OTHERWISE

SMOKE ALARMS TO CONFORM WITH CAN/ULC - S531, REFER

TO BCBC 2018

| K | DPA | 2023-09-12 |
|------------------------|--|--|
| J | revised | 2023-08-22 |
| ı | revised | 2023-08-08 |
| Н | revised | 2023-07-31 |
| G | revised | 2023-07-10 |
| F | revised | 2023-06-27 |
| E | consultant review | 2023-05-05 |
| no. | issue description | date |
| copyright remain th | reserved, these drawings and designs e property of Coast + Beam Architect | are and at all times ure to be used for the |

project shown and may not be reproduced without written consent.


Van Mol / Freeman Residence

Highland Road sheet title

Survey/Assemblies

| e | 2023-09-12 |
|----|------------|
| le | as noted |

drawn by Amanda Hoy

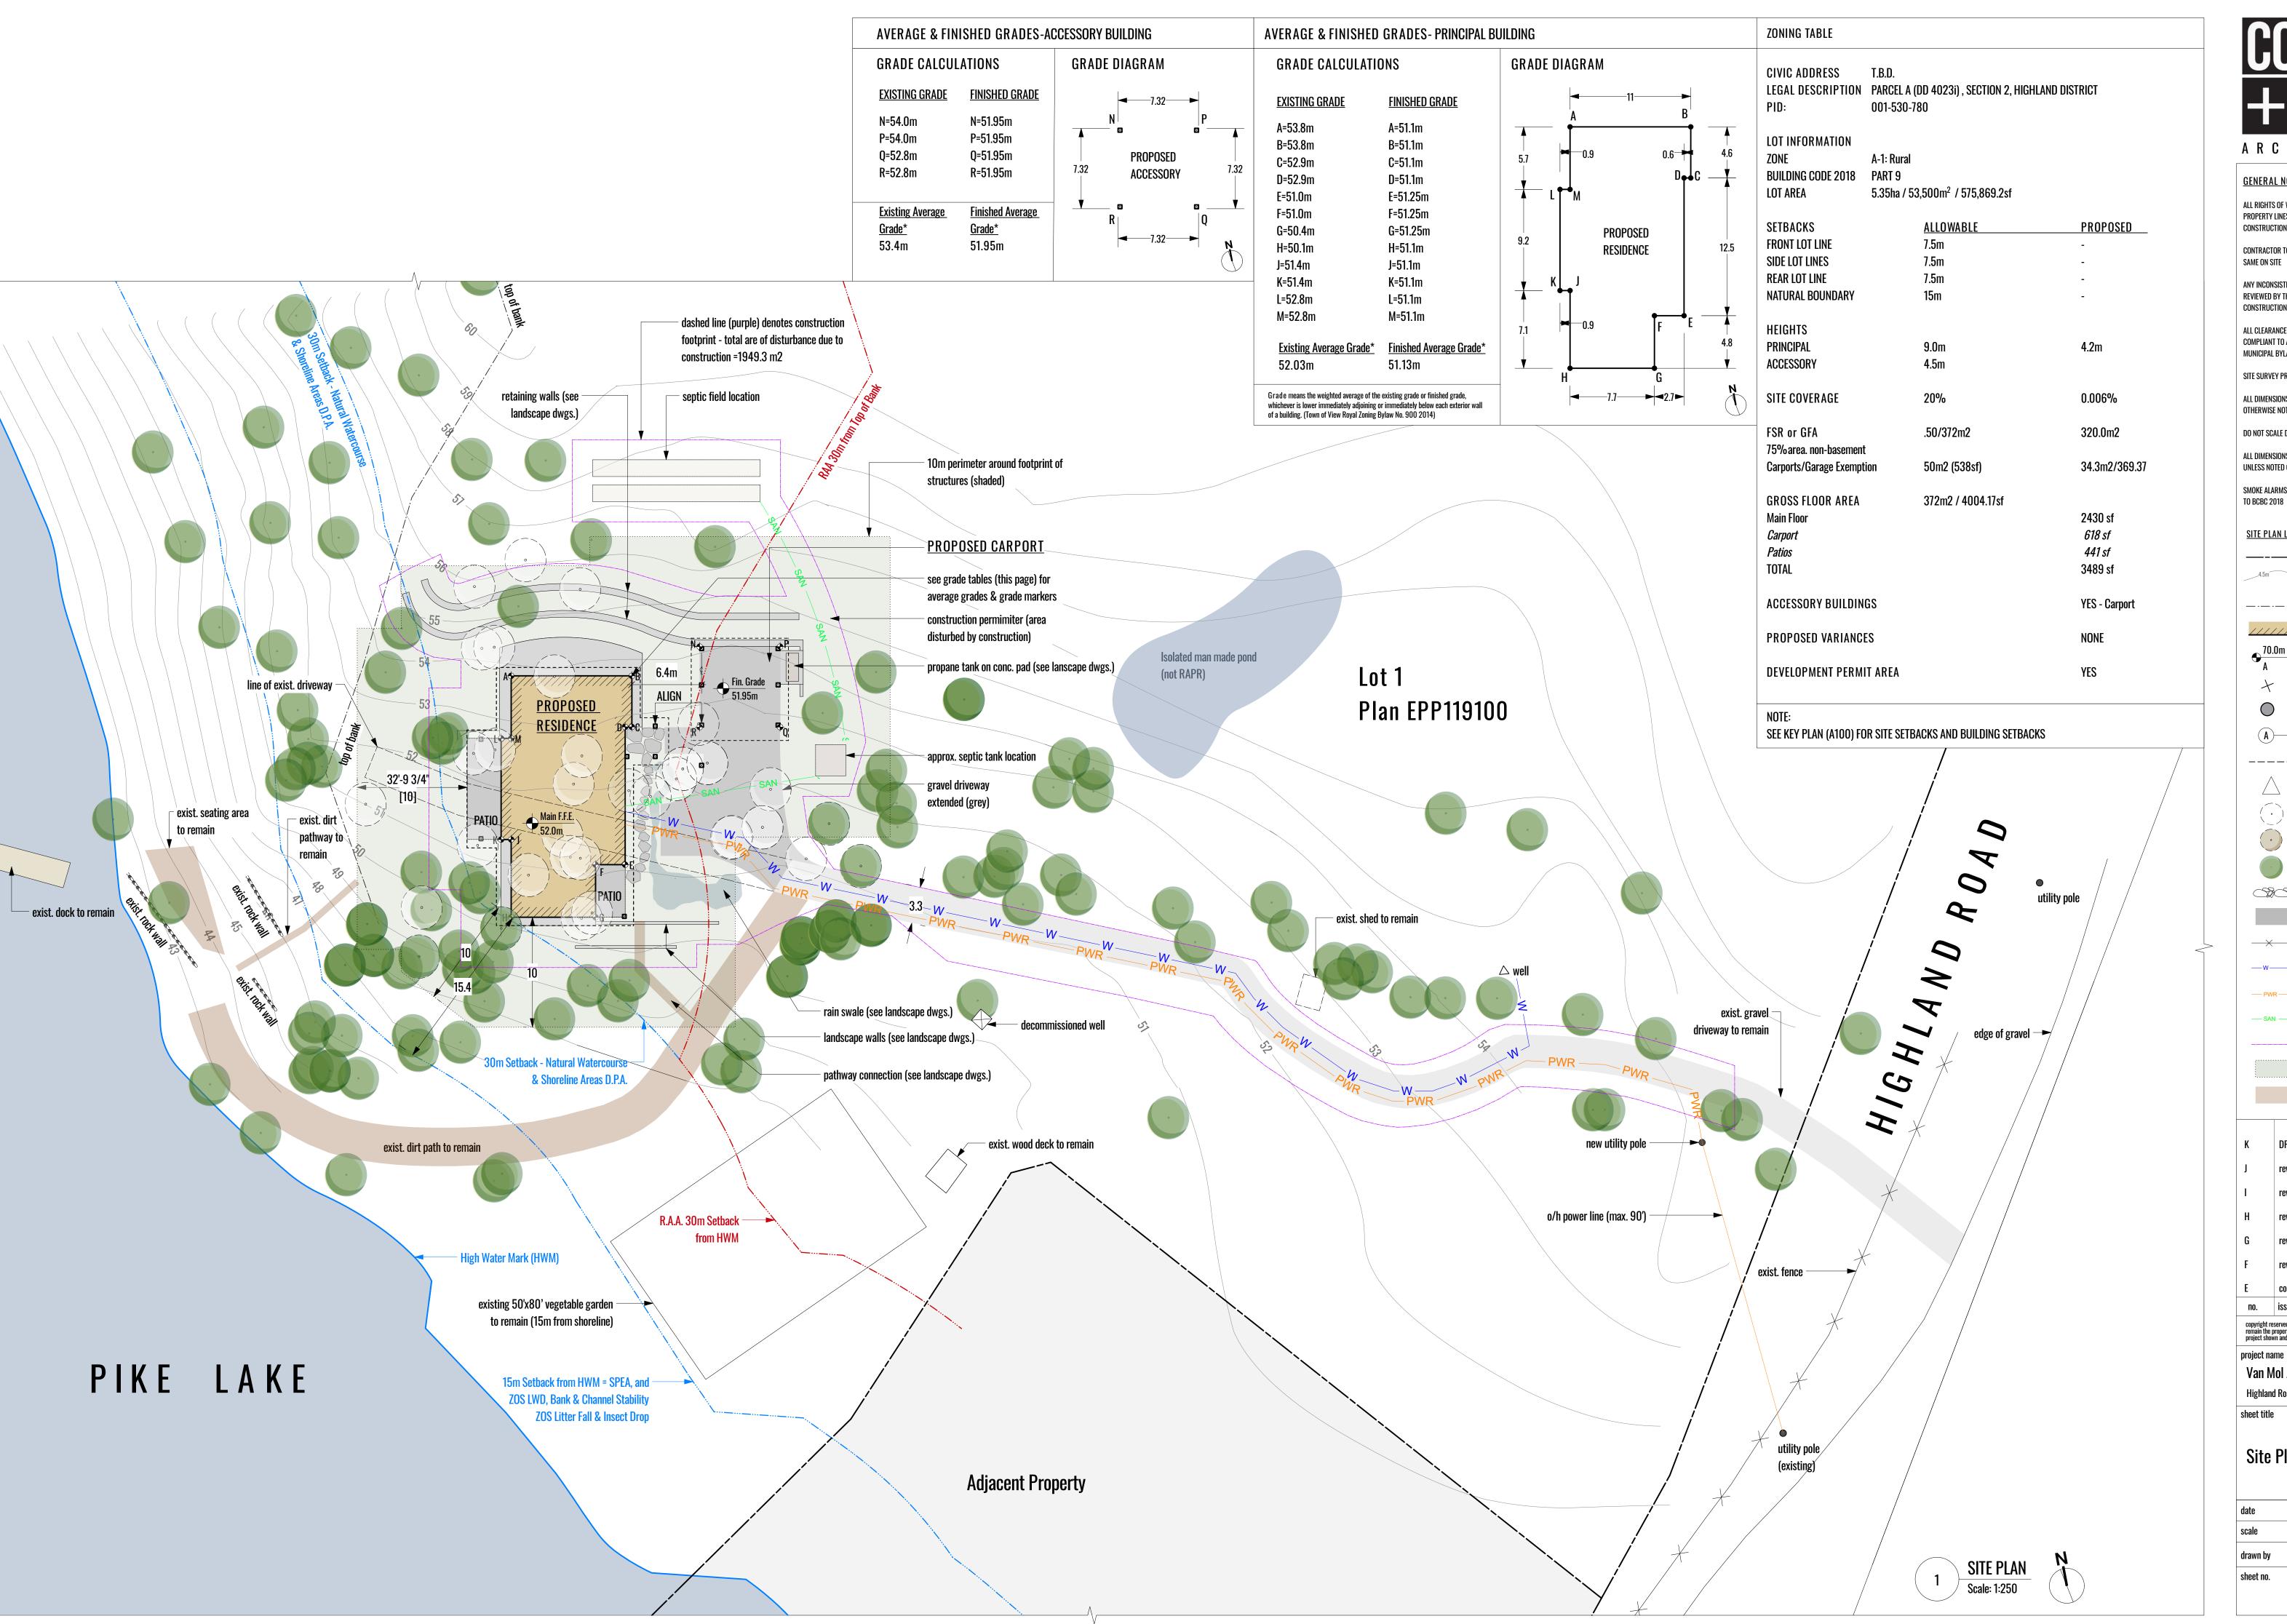



ALL RIGHTS OF WAY BOUNDARIES, SETBACKS AND PROPERTY LINES TO BE CONFIRMED BY B.C.L.S. PRIOR TO

CONTRACTOR TO VERIFY ALL DIMENSIONS AND CONFIRM

ANY INCONSISTENCIES OR UNFORESEEN CONDITIONS TO BE REVIEWED BY THE ARCHITECT PRIOR TO PROCEEDING WITH

CONSTRUCTION ALL CLEARANCES, METHODS AND MATERIALS TO BE

COMPLIANT TO ALL APPLICABLE BUILDING CODES AND

MUNICIPAL BYLAWS

SITE SURVEY PROVIDED BY SUMMIT LAND SURVEYING INC.

ALL DIMENSIONS ARE IN FEET AND INCHES UNLESS OTHERWISE NOTED

DO NOT SCALE DRAWINGS ALL DIMENSIONS ARE MEASURED TO FACE OF STRUCTURE,

UNLESS NOTED OTHERWISE

SMOKE ALARMS TO CONFORM WITH CAN/ULC - S531, REFER TO BCBC 2018

SITE PLAN LEGEND

————— PROPERTY LINE CONTOUR LINE — · — · TOP OF BANK PROPOSED FOOTPRINT

> **ELEVATION MARKER** WATER METER

UTILITY POLE

---- ROOF ABOVE

TREE TO BE REMOVED

TREE REMOVAL T.B.D ON SITE

EXISTING ROCK WALL

CONCRETE PATIO - cast in place

EXISTING FENCE

UNDERGROUND WATER LINE

UNDERGROUND POWER LINE

SANITARY LINE

CONSTRUCTION PERIMETER 10m PERIMETER (from footprint)

DIRT PATHWAY / AREA

2023-09-12 2023-08-08

copyright reserved. these drawings and designs are and at all times remain the property of Coast + Beam Architecture to be used for the project shown and may not be reproduced without written consent.


Van Mol / Freeman Residence

Highland Road

no. issue description

Site Plan/Zoning

| date | 2023-09-1 |
|-------|-----------|
| scale | as note |
| d b | A 1.11 |

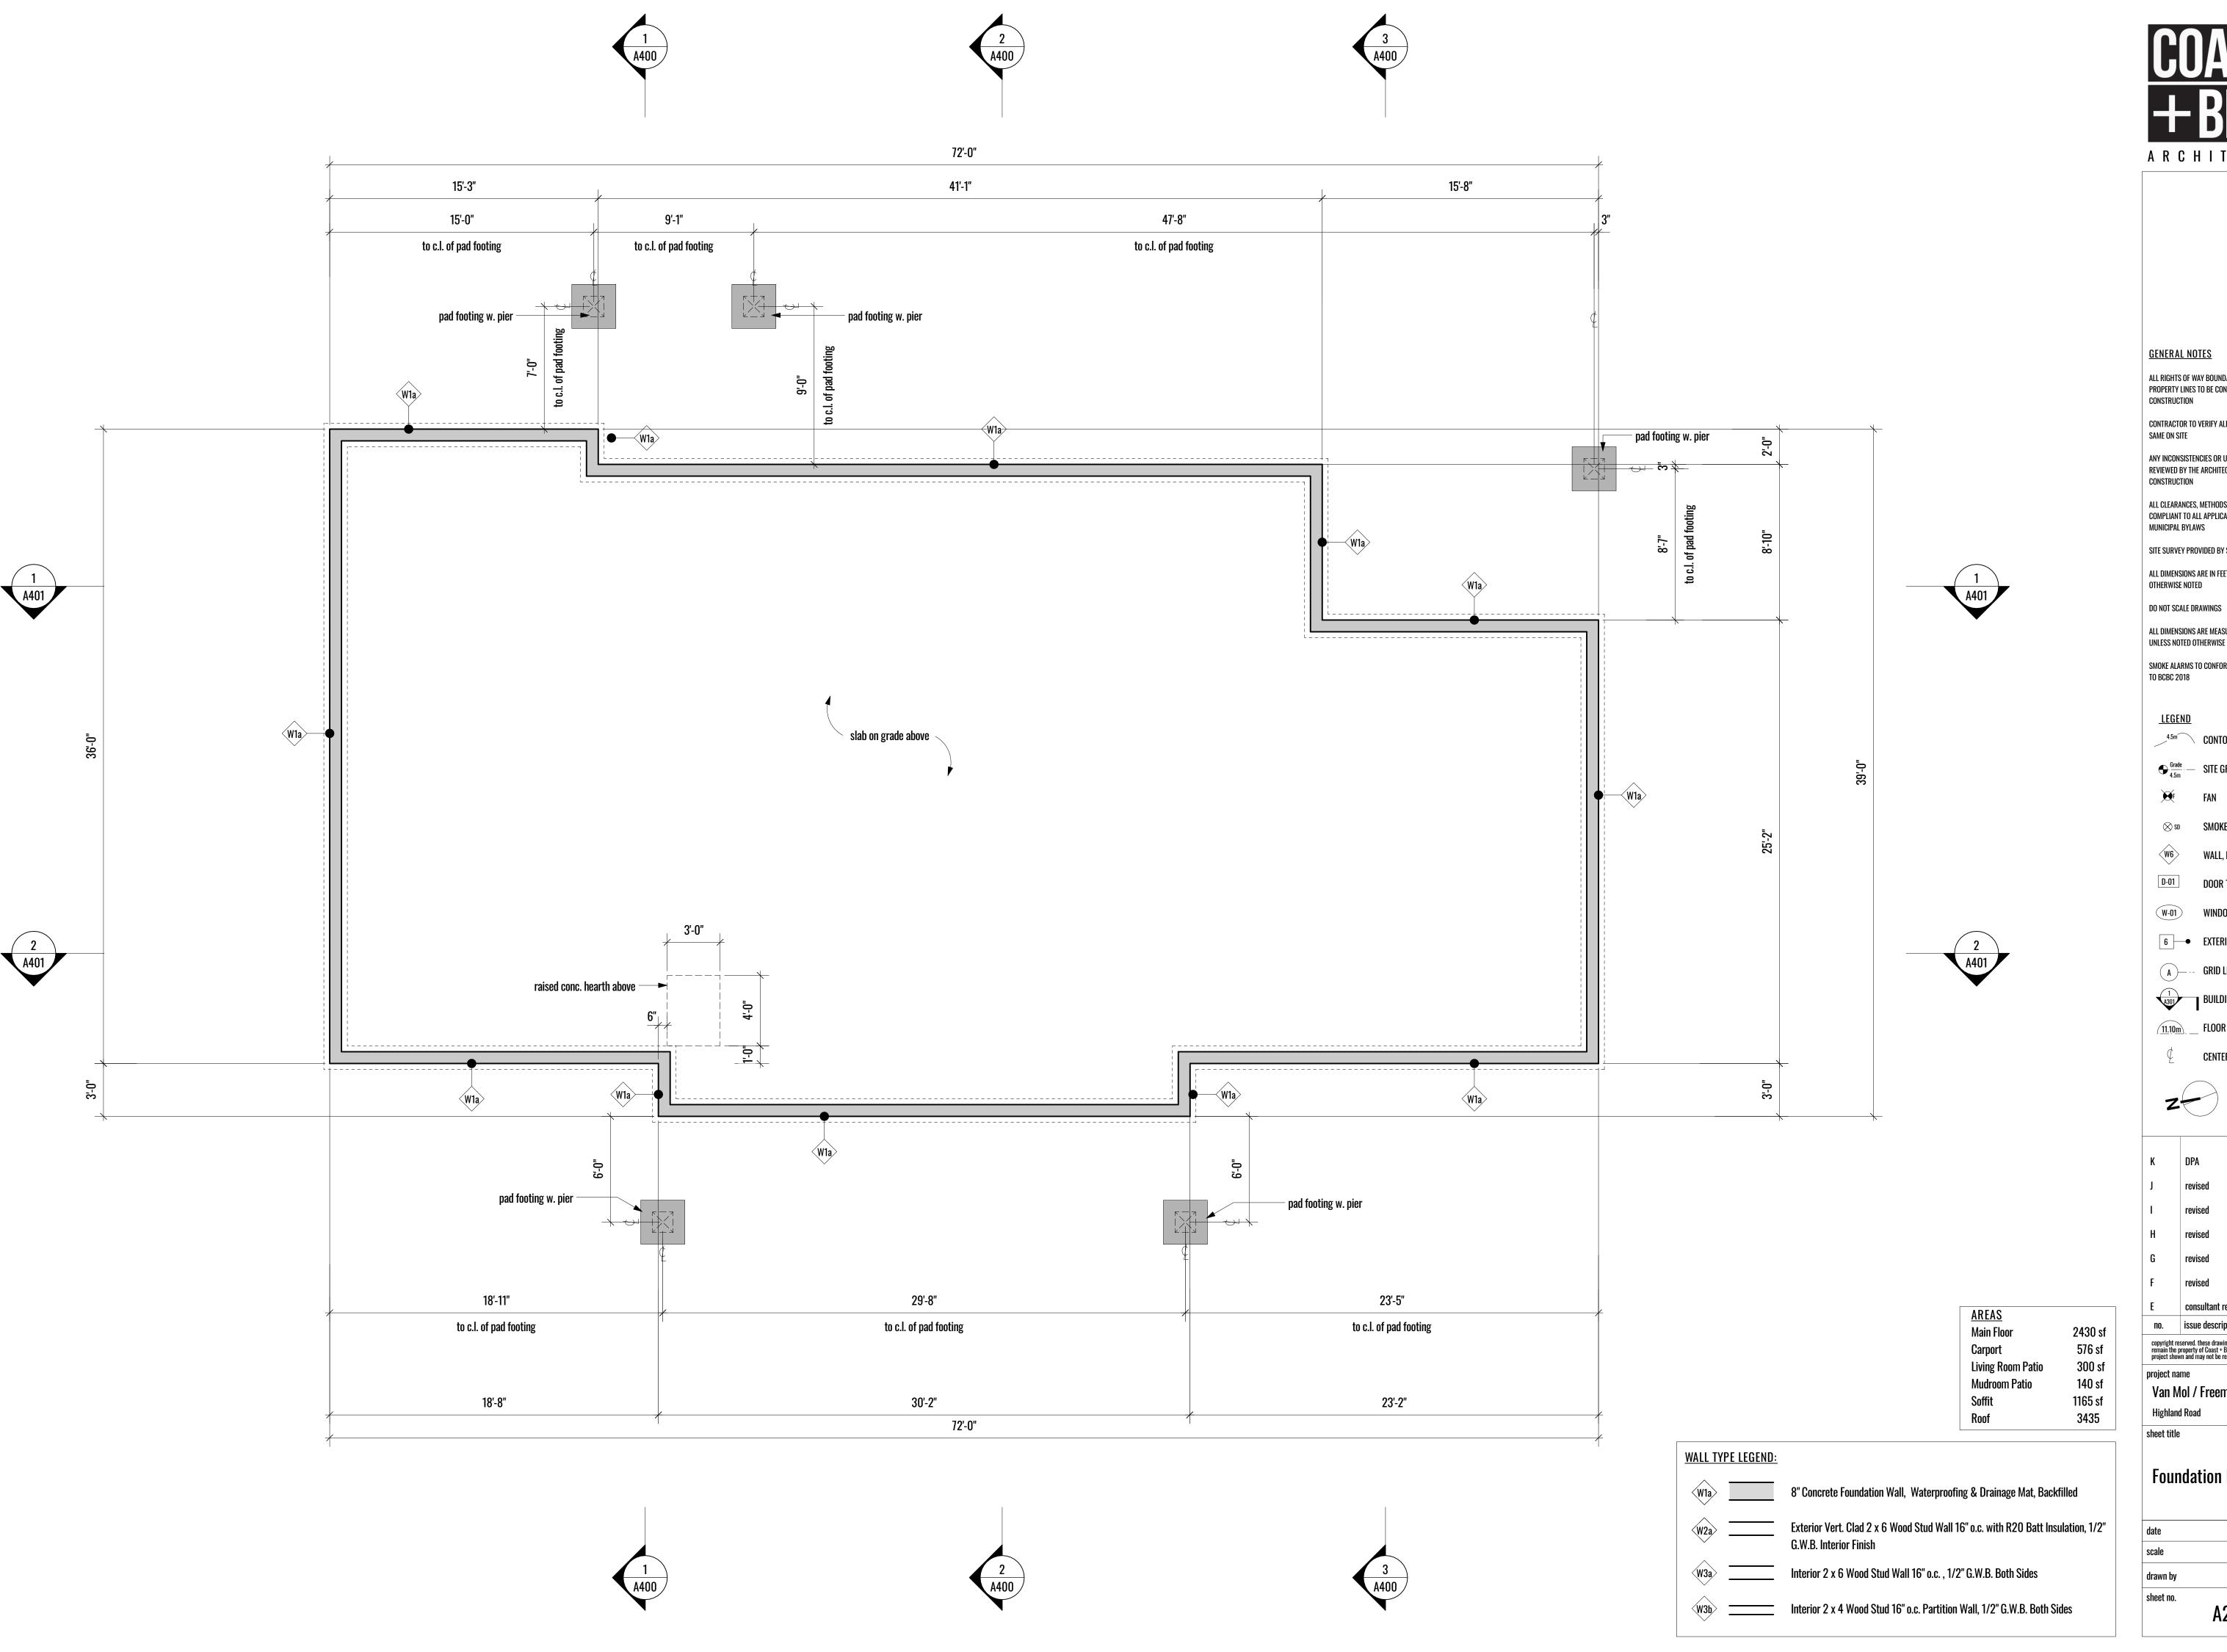



ALL RIGHTS OF WAY BOUNDARIES, SETBACKS AND PROPERTY LINES TO BE CONFIRMED BY B.C.L.S. PRIOR TO

CONTRACTOR TO VERIFY ALL DIMENSIONS AND CONFIRM

ANY INCONSISTENCIES OR UNFORESEEN CONDITIONS TO BE REVIEWED BY THE ARCHITECT PRIOR TO PROCEEDING WITH

ALL CLEARANCES, METHODS AND MATERIALS TO BE

COMPLIANT TO ALL APPLICABLE BUILDING CODES AND MUNICIPAL BYLAWS

SITE SURVEY PROVIDED BY SUMMIT LAND SURVEYING INC. ALL DIMENSIONS ARE IN FEET AND INCHES UNLESS

OTHERWISE NOTED

ALL DIMENSIONS ARE MEASURED TO FACE OF STRUCTURE,

UNLESS NOTED OTHERWISE

SMOKE ALARMS TO CONFORM WITH CAN/ULC - S531, REFER TO BCBC 2018

4.5m CONTOUR LINE

WALL, FLOOR AND ROOF TAG

DOOR TAG

WINDOW TAG

6 EXTERIOR FINISH SYMBOL

A --- GRID LINE

BUILDING SECTION

11.10m FLOOR ELEVATION

CENTERLINE




| K | DPA | 2023-09-12 |
|-----|-------------------|------------|
| J | revised | 2023-08-22 |
| 1 | revised | 2023-08-08 |
| Н | revised | 2023-07-31 |
| G | revised | 2023-07-10 |
| F | revised | 2023-06-27 |
| E | consultant review | 2023-05-05 |
| no. | issue description | date |
| | | |

copyright reserved. these drawings and designs are and at all times remain the property of Coast + Beam Architecture to be used for the project shown and may not be reproduced without written consent.

Van Mol / Freeman Residence

Foundation Plan

| date | 2023-09-12 |
|-----------|------------|
| scale | as noted |
| drawn by | Amanda Hoy |
| sheet no. | |

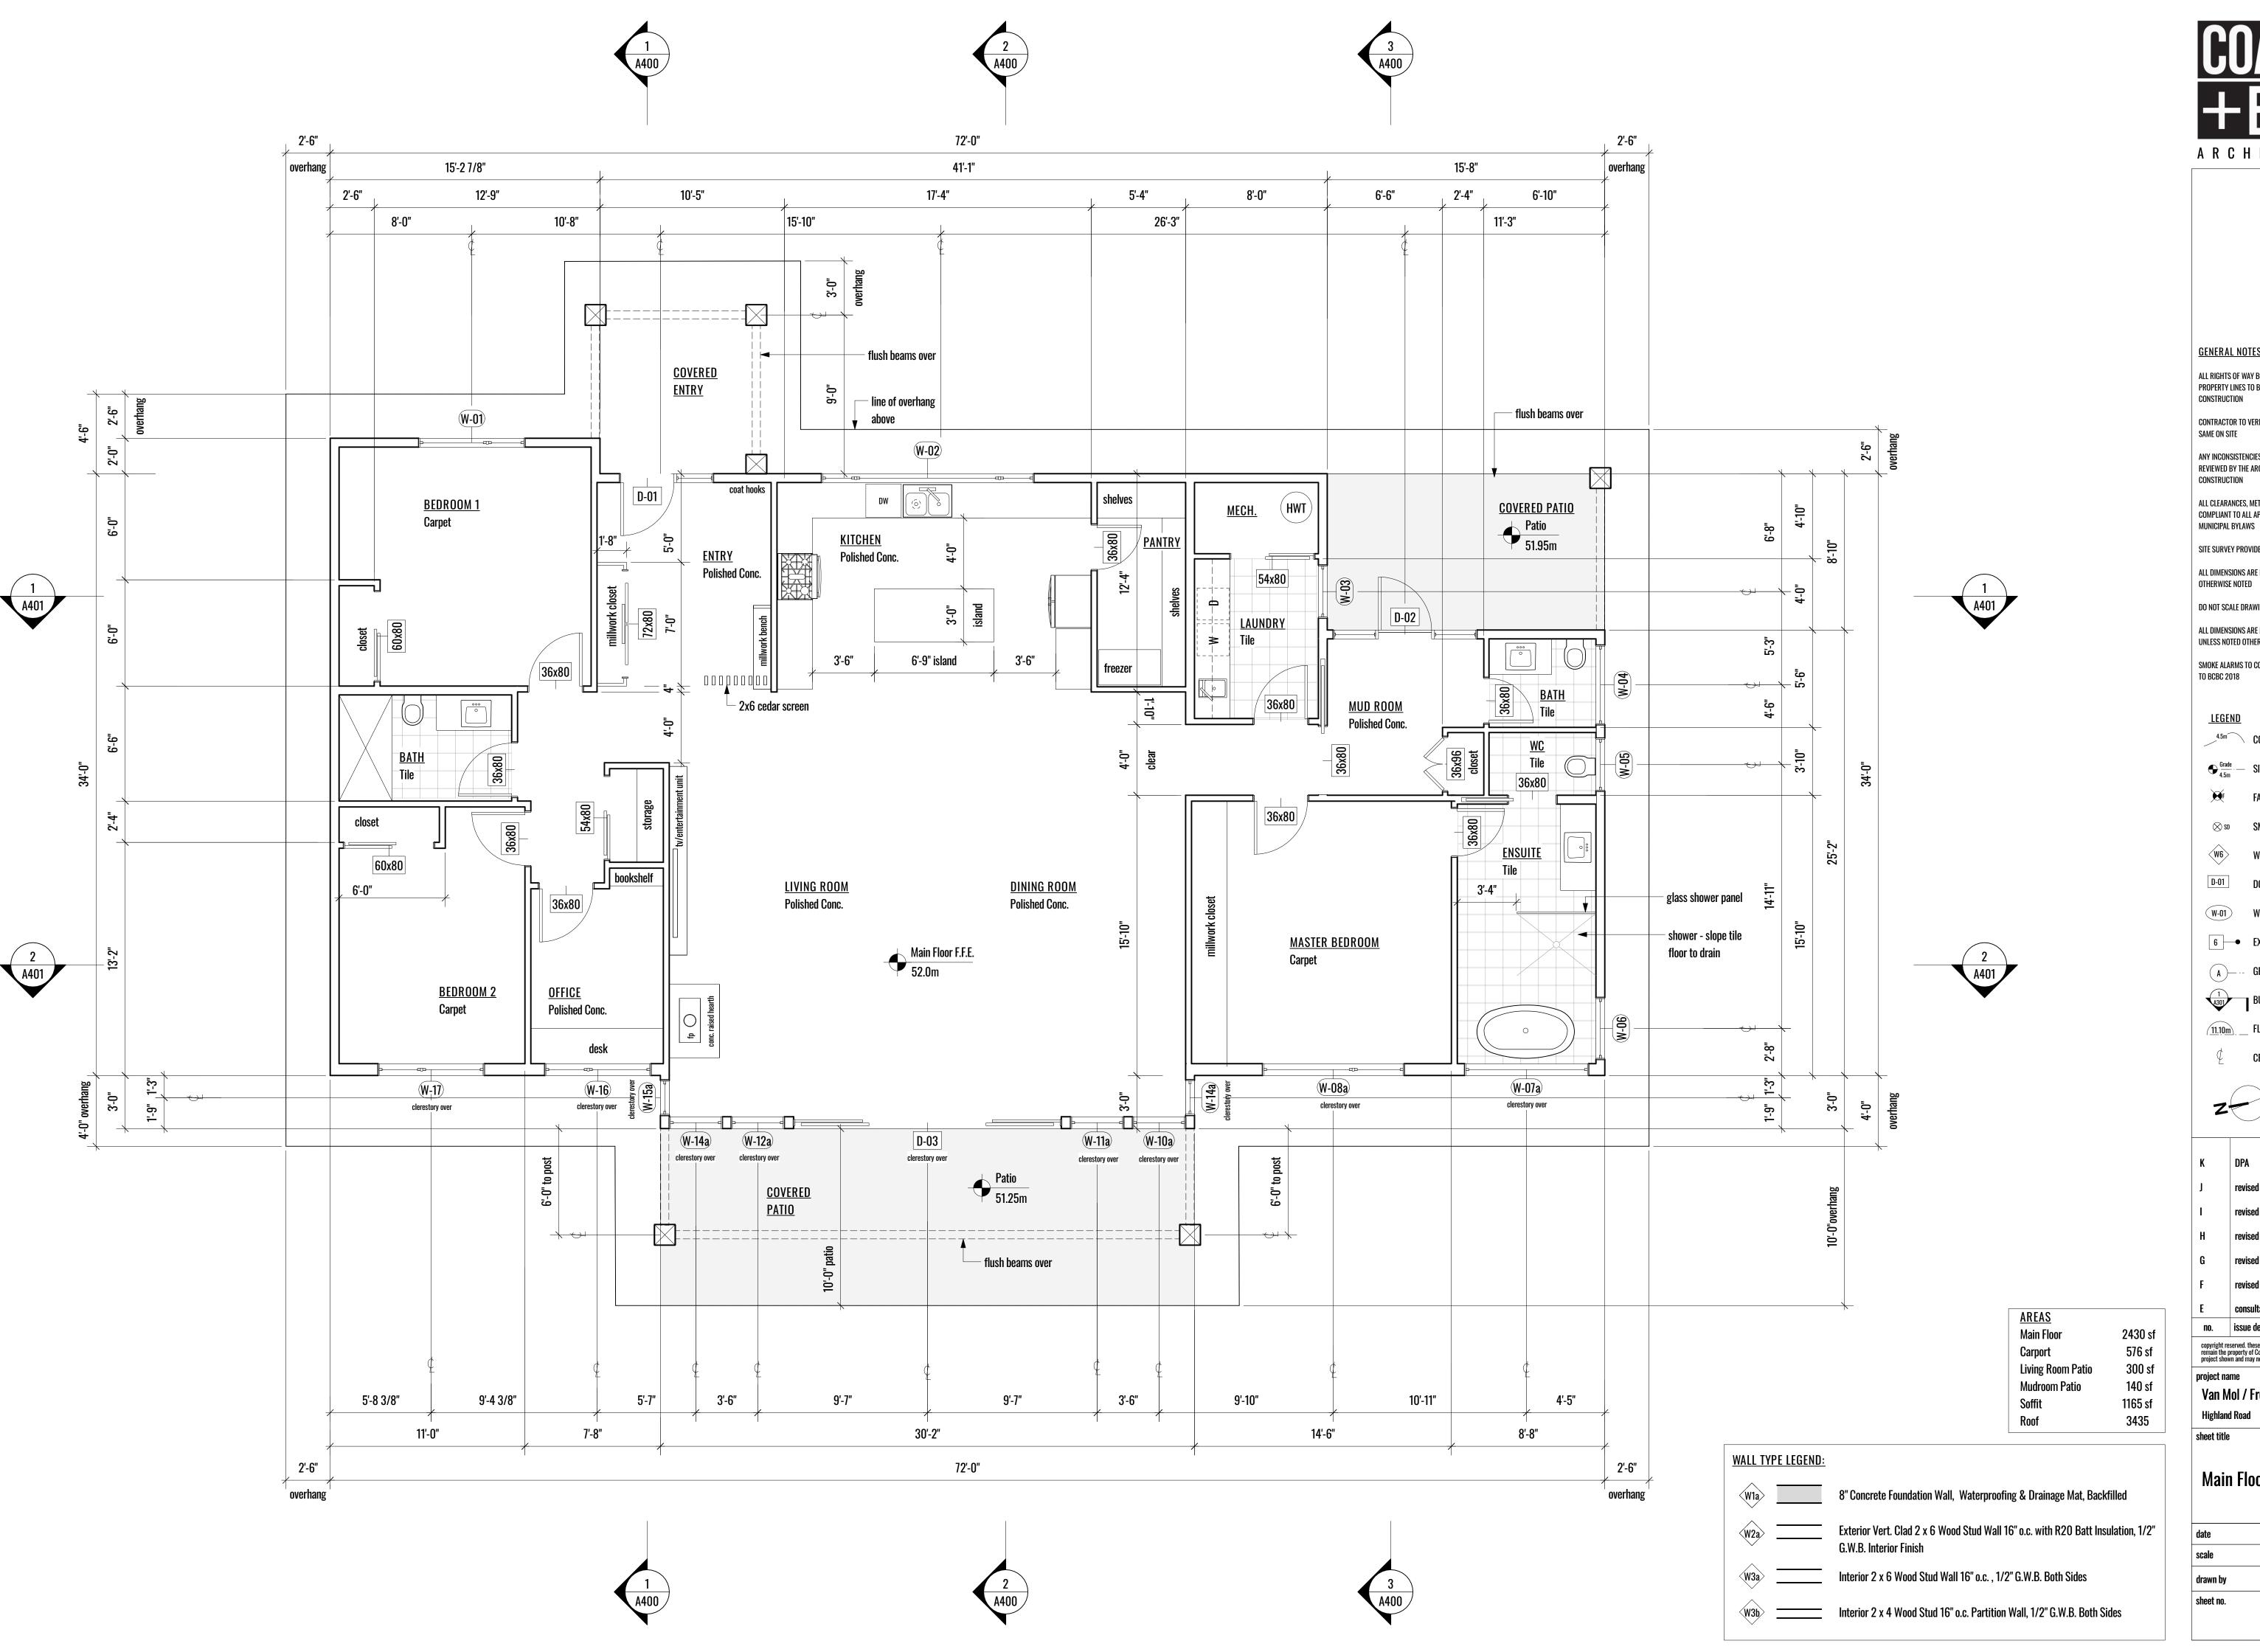



ALL RIGHTS OF WAY BOUNDARIES, SETBACKS AND PROPERTY LINES TO BE CONFIRMED BY B.C.L.S. PRIOR TO

CONTRACTOR TO VERIFY ALL DIMENSIONS AND CONFIRM

ANY INCONSISTENCIES OR UNFORESEEN CONDITIONS TO BE REVIEWED BY THE ARCHITECT PRIOR TO PROCEEDING WITH

ALL CLEARANCES, METHODS AND MATERIALS TO BE COMPLIANT TO ALL APPLICABLE BUILDING CODES AND

MUNICIPAL BYLAWS

SITE SURVEY PROVIDED BY SUMMIT LAND SURVEYING INC. ALL DIMENSIONS ARE IN FEET AND INCHES UNLESS

DO NOT SCALE DRAWINGS

ALL DIMENSIONS ARE MEASURED TO FACE OF STRUCTURE, UNLESS NOTED OTHERWISE

SMOKE ALARMS TO CONFORM WITH CAN/ULC - S531, REFER TO BCBC 2018

4.5m CONTOUR LINE

SMOKE DETECTOR

WALL, FLOOR AND ROOF TAG

DOOR TAG

W-01 WINDOW TAG

6 EXTERIOR FINISH SYMBOL

A --- GRID LINE

BUILDING SECTION

11.10m FLOOR ELEVATION

CENTERLINE




| no. | issue description | date |
|-----|-------------------|------------|
| E | consultant review | 2023-05-05 |
| F | revised | 2023-06-27 |
| G | revised | 2023-07-10 |
| Н | revised | 2023-07-31 |
| 1 | revised | 2023-08-08 |
| J | revised | 2023-08-22 |
| K | DPA | 2023-09-12 |
| | | |

copyright reserved. these drawings and designs are and at all times remain the property of Coast + Beam Architecture to be used for the project shown and may not be reproduced without written consent.

Van Mol / Freeman Residence

Main Floor Plan

| date | 2023-09-12 |
|----------|------------|
| scale | as noted |
| drawn by | Amanda Hoy |
| sheet no | |

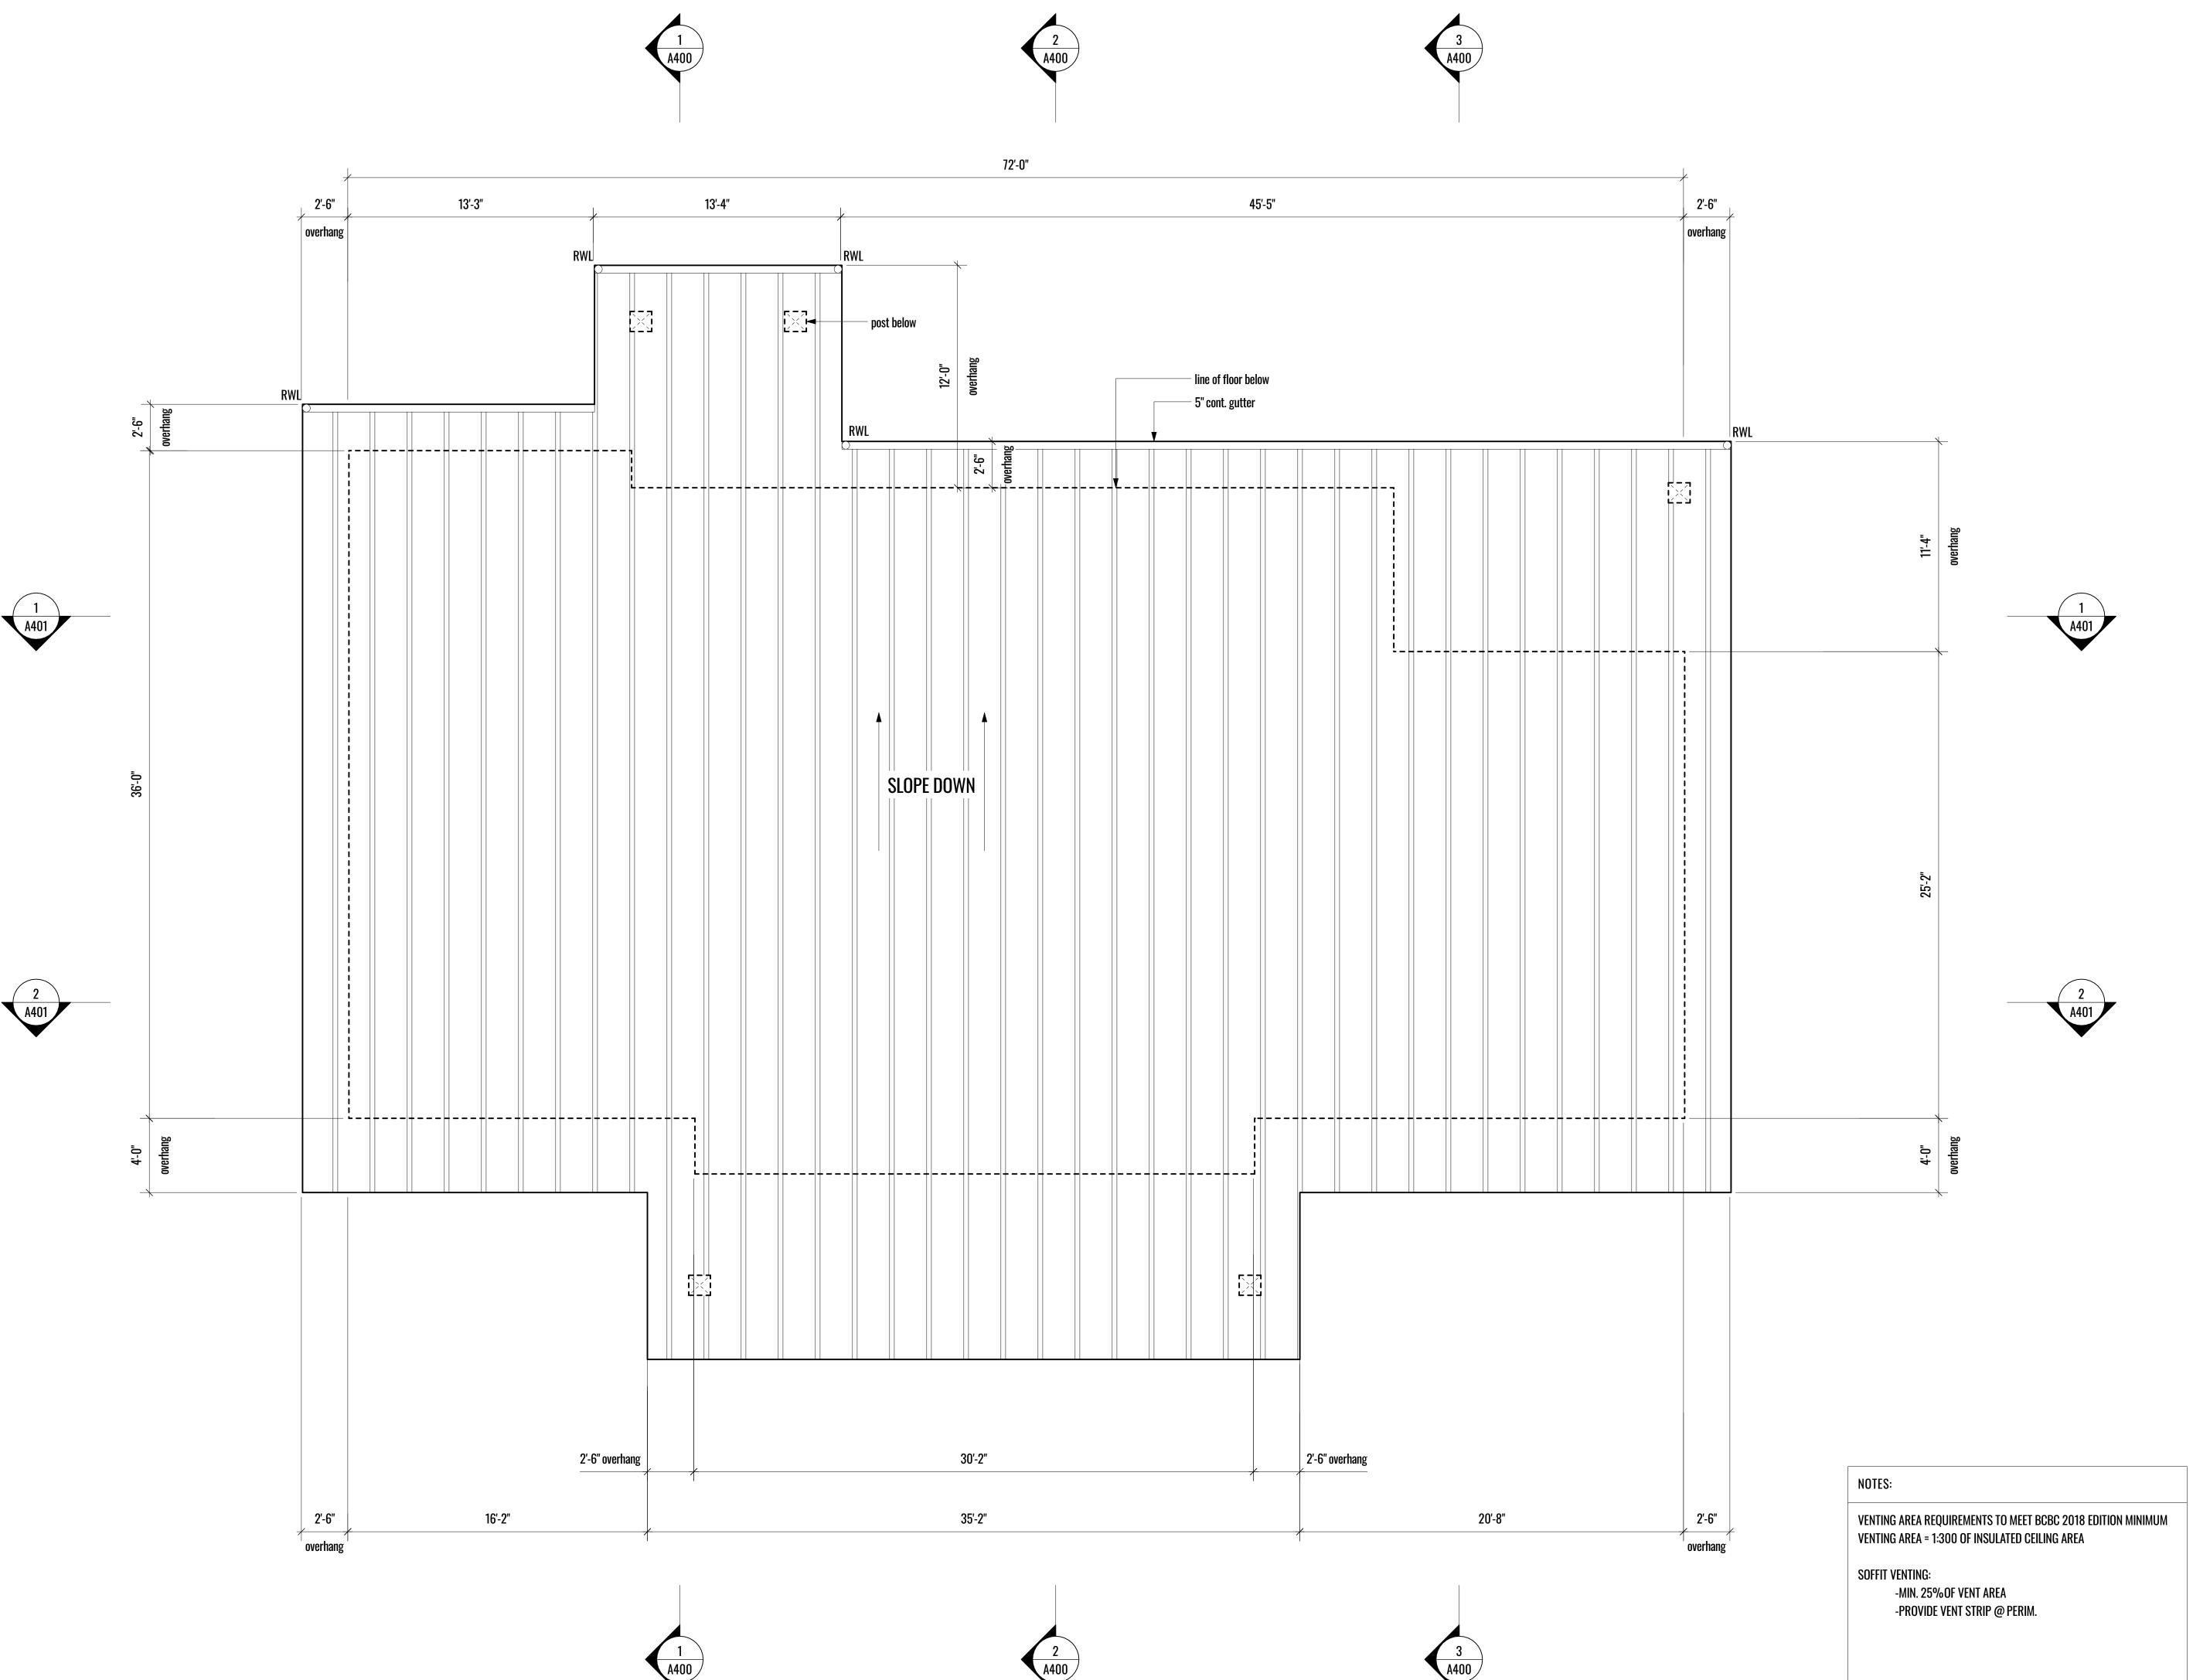



ALL RIGHTS OF WAY BOUNDARIES, SETBACKS AND PROPERTY LINES TO BE CONFIRMED BY B.C.L.S. PRIOR TO CONSTRUCTION

CONTRACTOR TO VERIFY ALL DIMENSIONS AND CONFIRM SAME ON SITE

ANY INCONSISTENCIES OR UNFORESEEN CONDITIONS TO BE REVIEWED BY THE ARCHITECT PRIOR TO PROCEEDING WITH CONSTRUCTION

ALL CLEARANCES, METHODS AND MATERIALS TO BE Compliant to all applicable building codes and

MUNICIPAL BYLAWS

SITE SURVEY PROVIDED BY SUMMIT LAND SURVEYING INC.

ALL DIMENSIONS ARE IN FEET AND INCHES UNLESS Otherwise noted

DO NOT SCALE DRAWINGS

ALL DIMENSIONS ARE MEASURED TO FACE OF STRUCTURE,

UNLESS NOTED OTHERWISE

SMOKE ALARMS TO CONFORM WITH CAN/ULC - S531, REFER TO BCBC 2018

LEGENL

4.5m CONTOUR LINE

Grade SITE GRADES

∮F FAN

 \otimes SD SMOKE DETECTOR

W6 WALL, FLOOR AND ROOF TAG

D-01 DOOR TAG

W-01 WINDOW TAG

6 — EXTERIOR FINISH SYMBOL

A --- GRID LINE

1

WALL SECTION

BUILDING SECTION

11.10m FLOOR ELEVATION



| 110. | issue description | date |
|-------------|-------------------|------------|
| E | consultant review | 2023-05-05 |
| F | revised | 2023-06-27 |
| G | revised | 2023-07-10 |
| Н | revised | 2023-07-31 |
| I | revised | 2023-08-08 |
| J | revised | 2023-08-22 |
| K | DPA | 2023-09-12 |
| | | |

copyright reserved. these drawings and designs are and at all times remain the property of Coast + Beam Architecture to be used for the project shown and may not be reproduced without written consent.

project name

Van Mol / Freeman Residence


Highland Road

sheet title

Roof Plan

sheet no.

| scale | as noted |
|-------|------------|
| scale | as noted |
| date | 2023-09-12 |

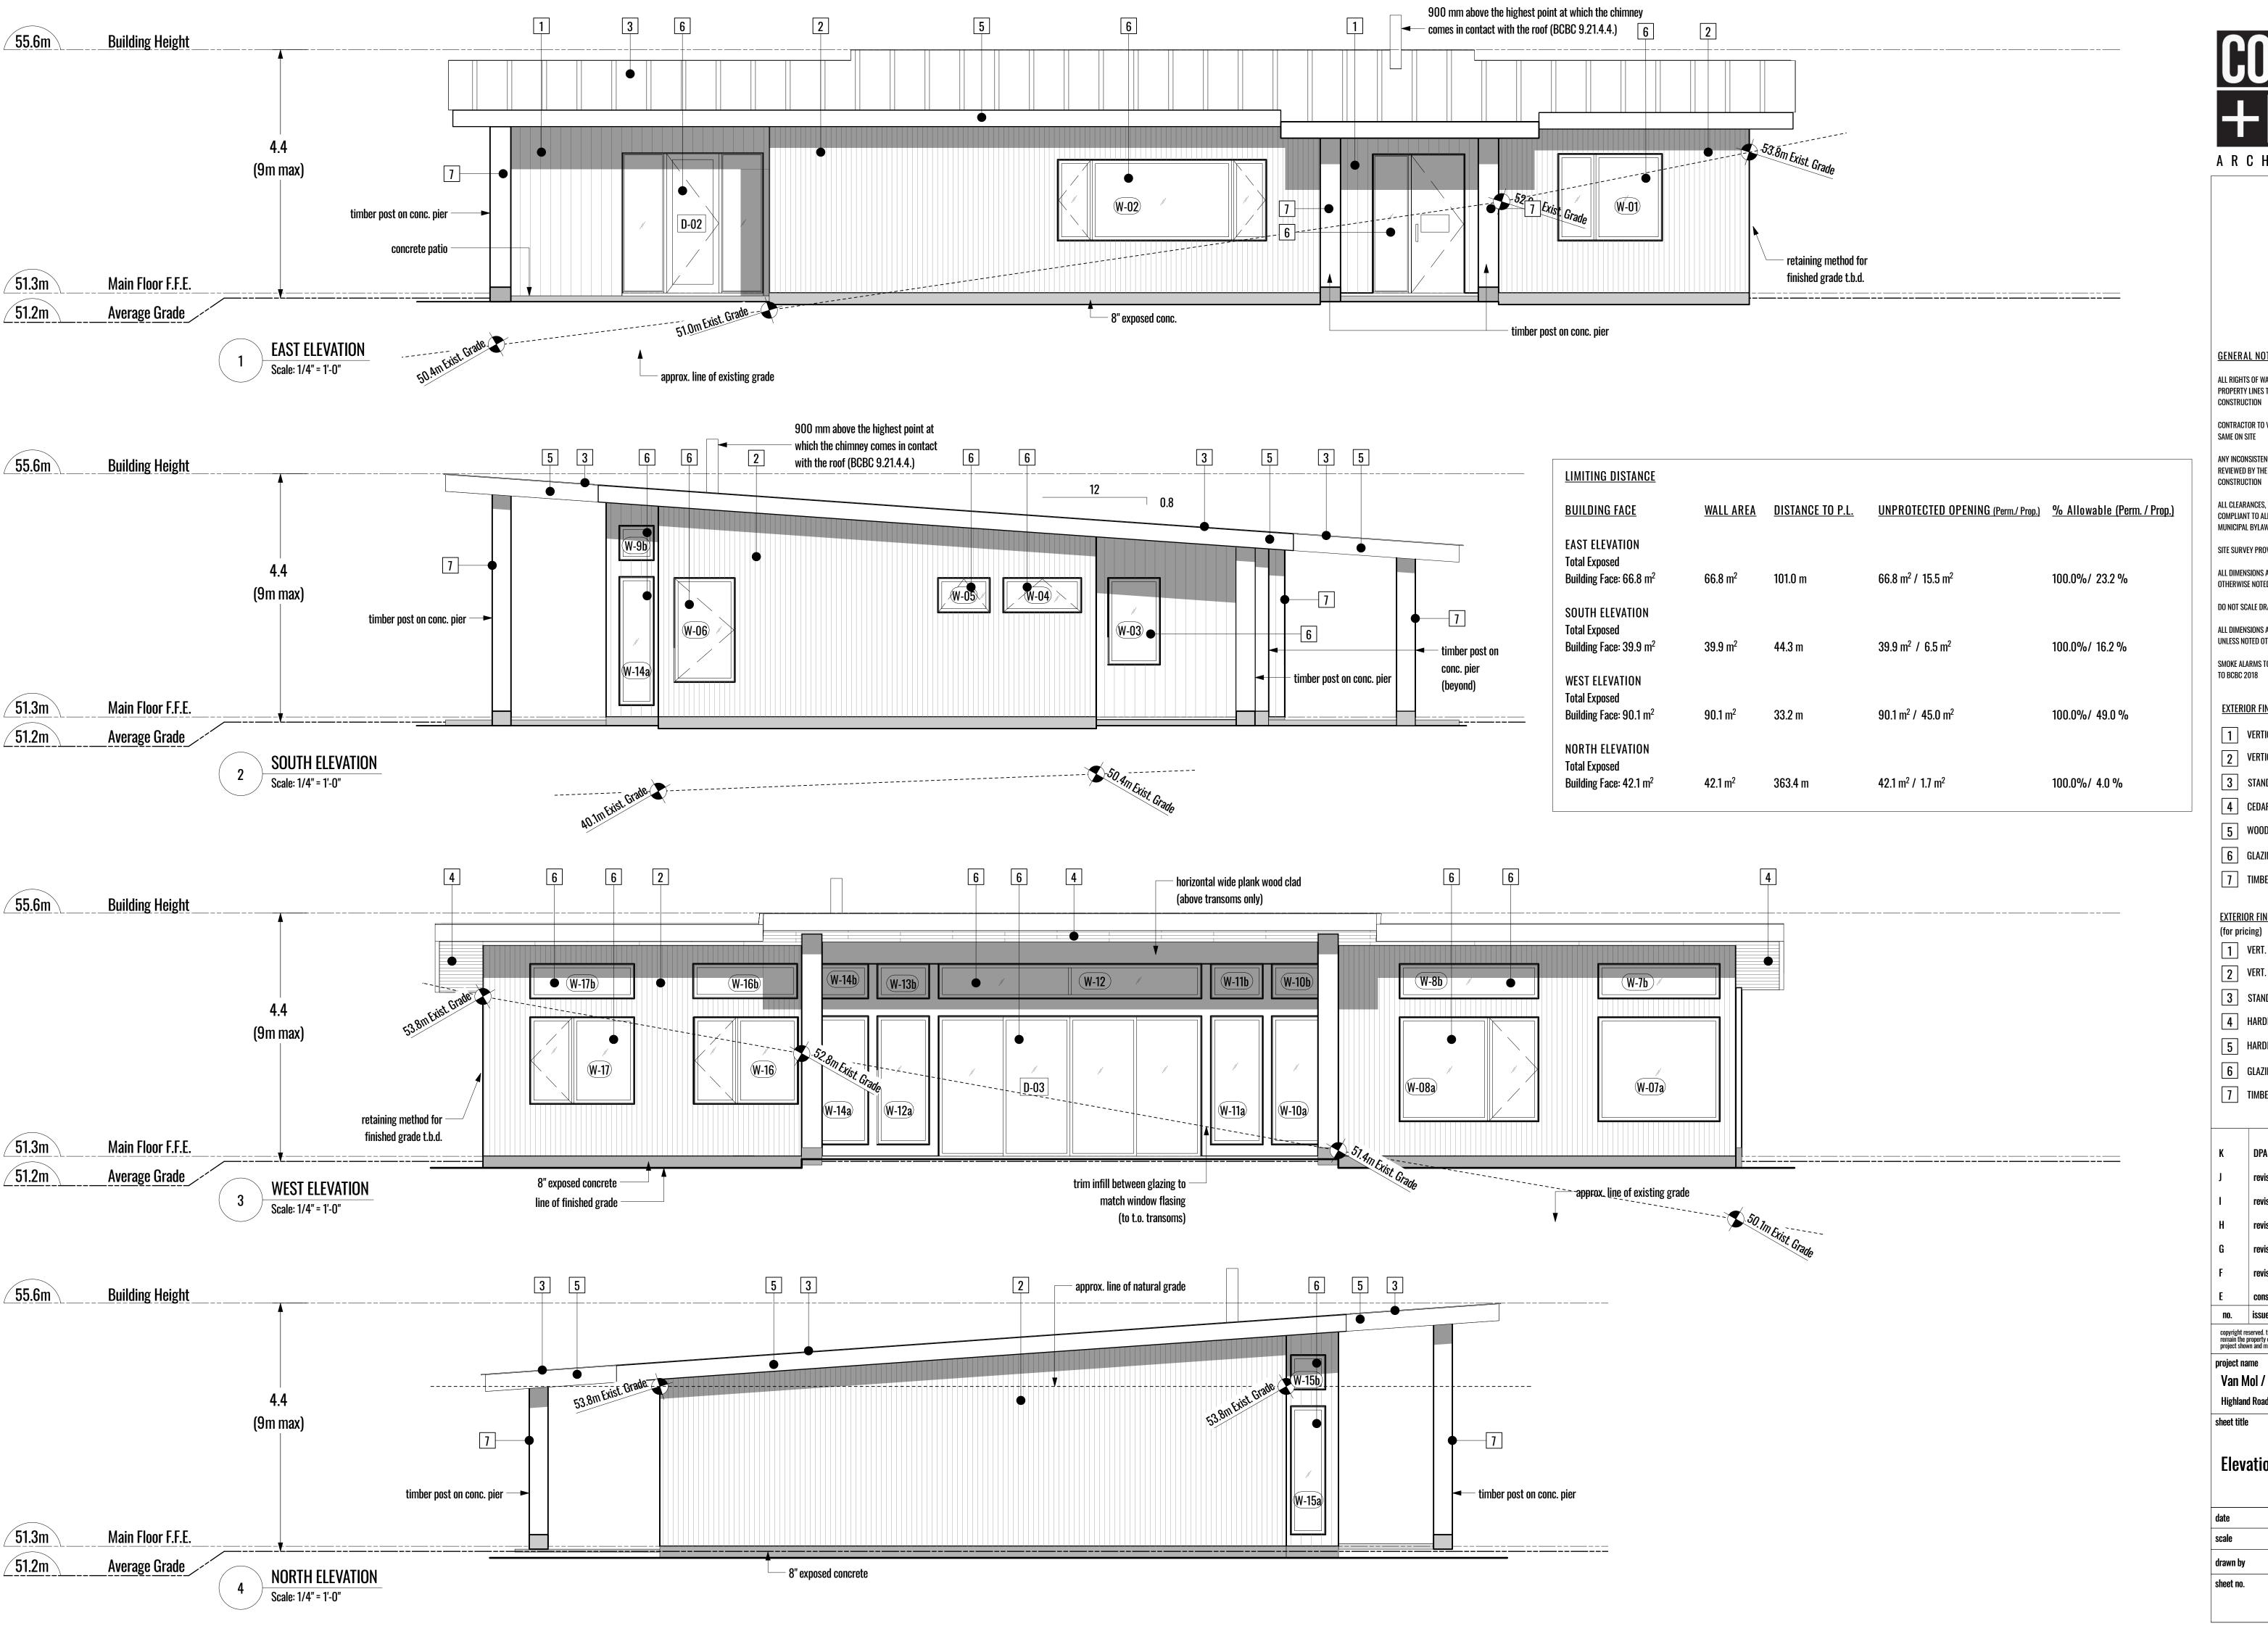



ALL RIGHTS OF WAY BOUNDARIES, SETBACKS AND PROPERTY LINES TO BE CONFIRMED BY B.C.L.S. PRIOR TO

CONTRACTOR TO VERIFY ALL DIMENSIONS AND CONFIRM SAME ON SITE

ANY INCONSISTENCIES OR UNFORESEEN CONDITIONS TO BE REVIEWED BY THE ARCHITECT PRIOR TO PROCEEDING WITH

ALL CLEARANCES, METHODS AND MATERIALS TO BE COMPLIANT TO ALL APPLICABLE BUILDING CODES AND

MUNICIPAL BYLAWS SITE SURVEY PROVIDED BY SUMMIT LAND SURVEYING INC.

ALL DIMENSIONS ARE IN FEET AND INCHES UNLESS OTHERWISE NOTED

DO NOT SCALE DRAWINGS

ALL DIMENSIONS ARE MEASURED TO FACE OF STRUCTURE, UNLESS NOTED OTHERWISE

SMOKE ALARMS TO CONFORM WITH CAN/ULC - S531, REFER

EXTERIOR FINISH SCHEDULE

1 VERTICAL CEDAR

2 VERTICAL SHOU SUGI BAN

3 STANDING SEAM METAL ROOF

4 CEDAR SOFFIT

5 WOOD FASCIA - black

6 GLAZING - w. black trim (u.n.o.)

7 TIMBER POST - clear stain

EXTERIOR FINISH SCHEDULE-ALTERNATE

(for pricing)

1 VERT. HARDIE - wood look

2 VERT. HARDIE - black

3 STANDING SEAM METAL ROOF

4 HARDIE SOFFIT - wood look

5 HARDIE FASCIA - black

6 GLAZING 7 TIMBER POST - clear stain

K DPA 2023-09-12 2023-08-22 2023-08-08 2023-07-31 2023-07-10 2023-06-27 2023-05-05 no. issue description

copyright reserved. these drawings and designs are and at all times remain the property of Coast + Beam Architecture to be used for the project shown and may not be reproduced without written consent.

project name


Van Mol / Freeman Residence **Highland Road**


sheet title


Elevations


| date | 2023-09-12 |
|----------|------------|
| scale | as noted |
| drawn by | Amanda Hoy |
| | |



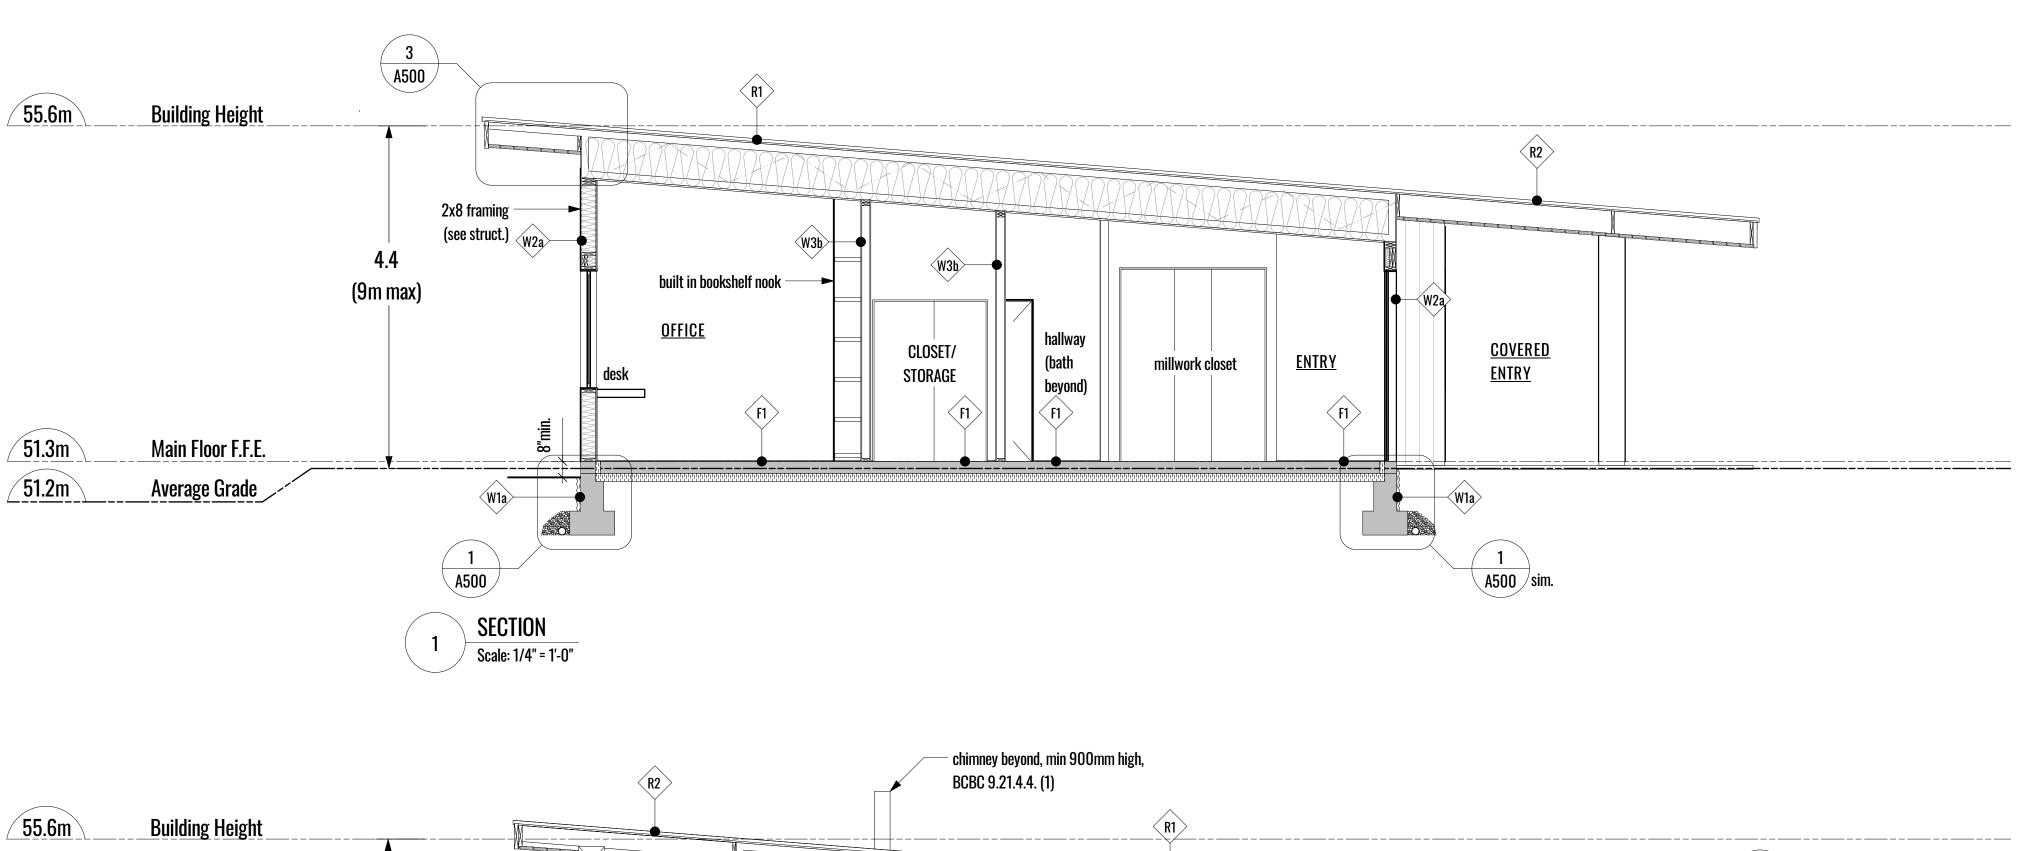

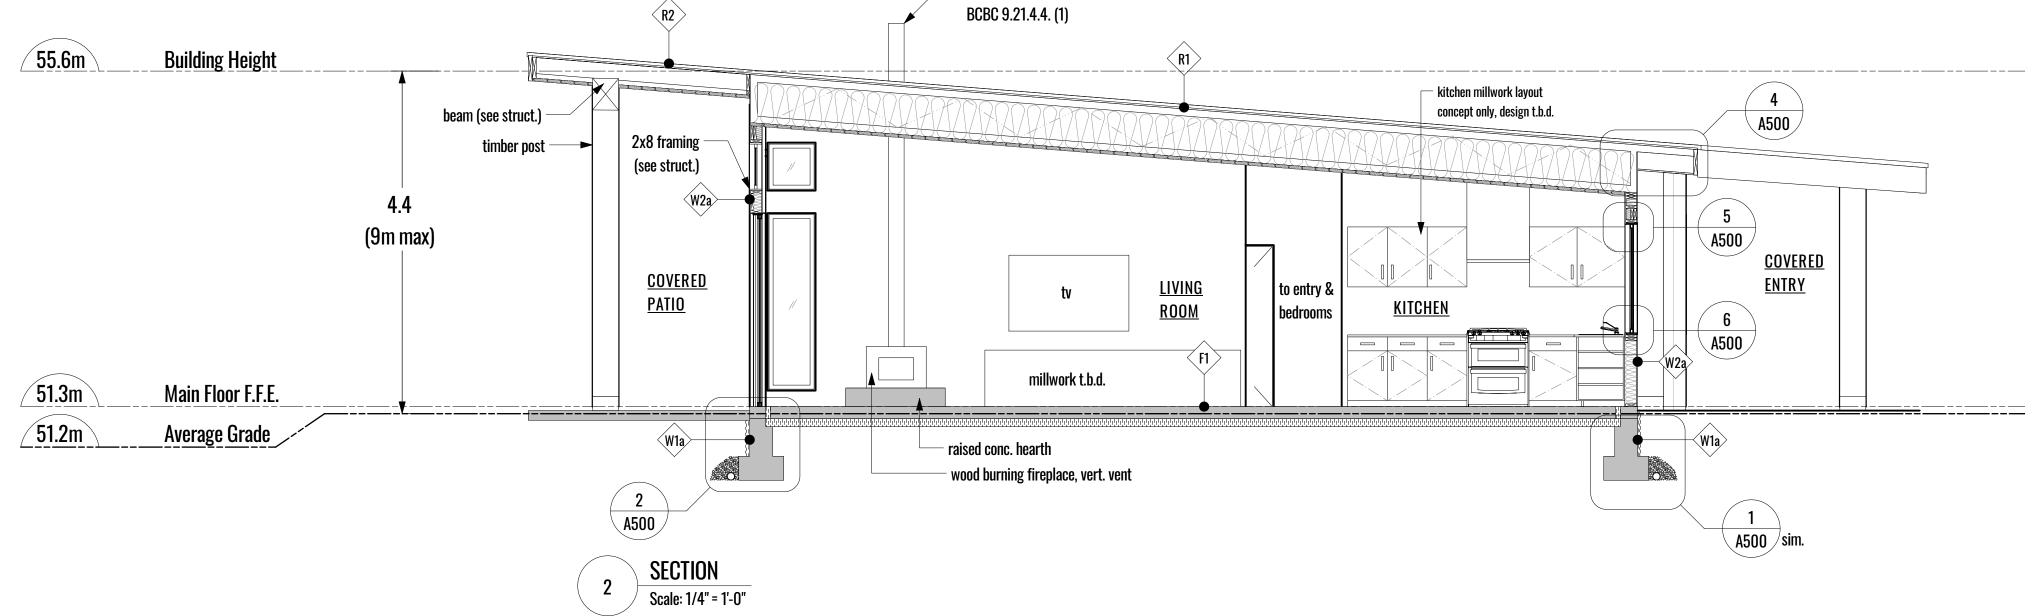

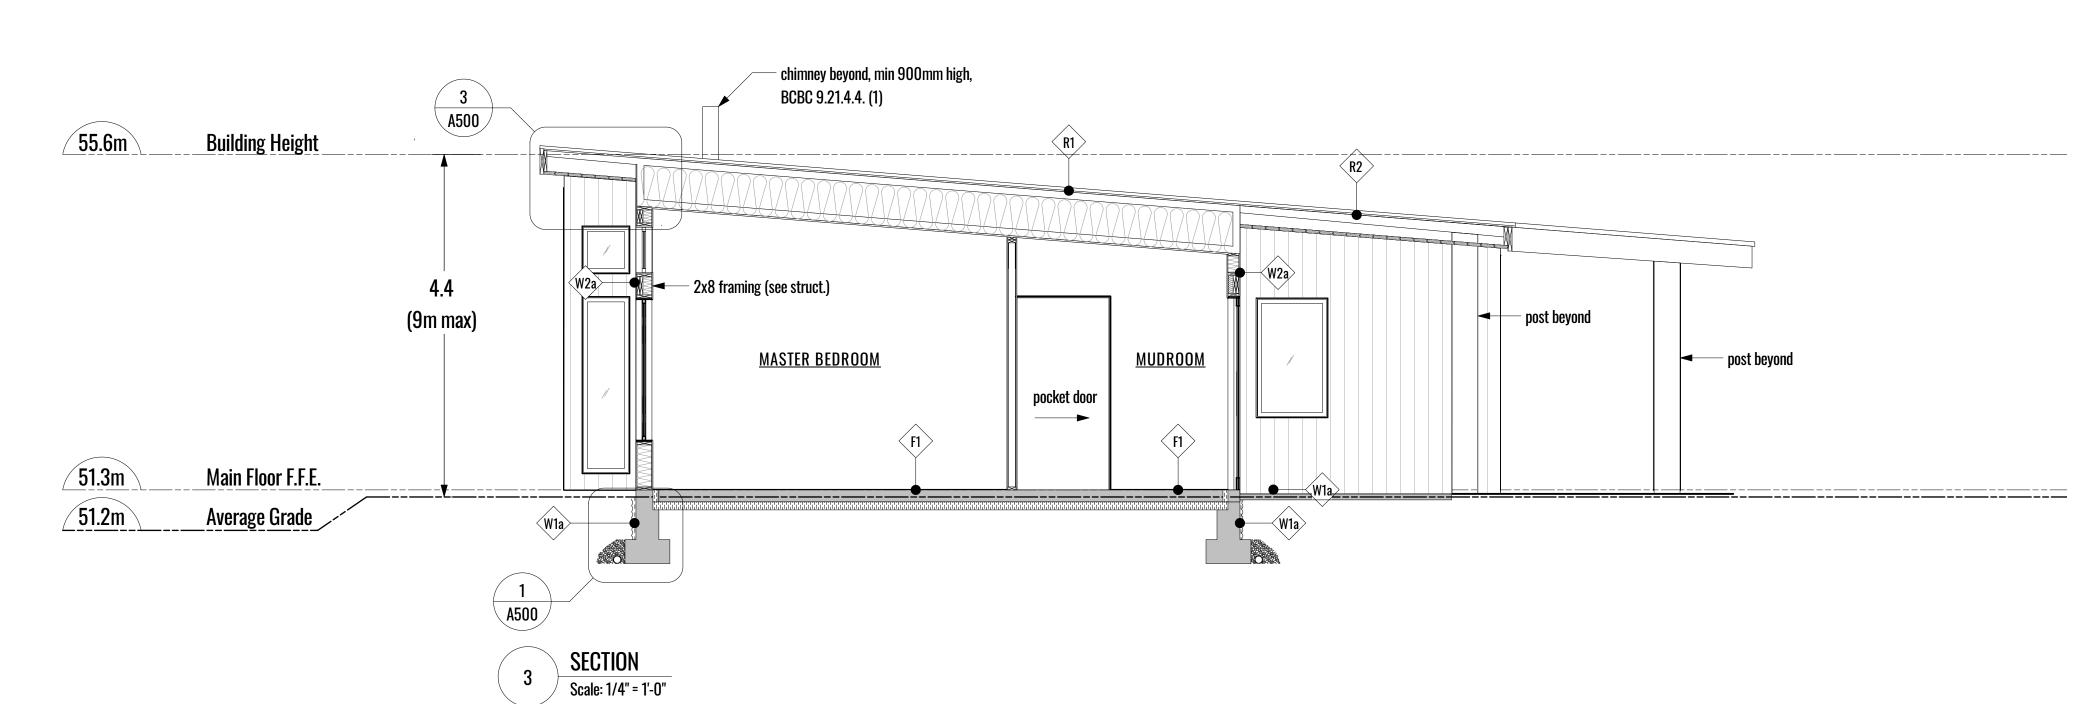

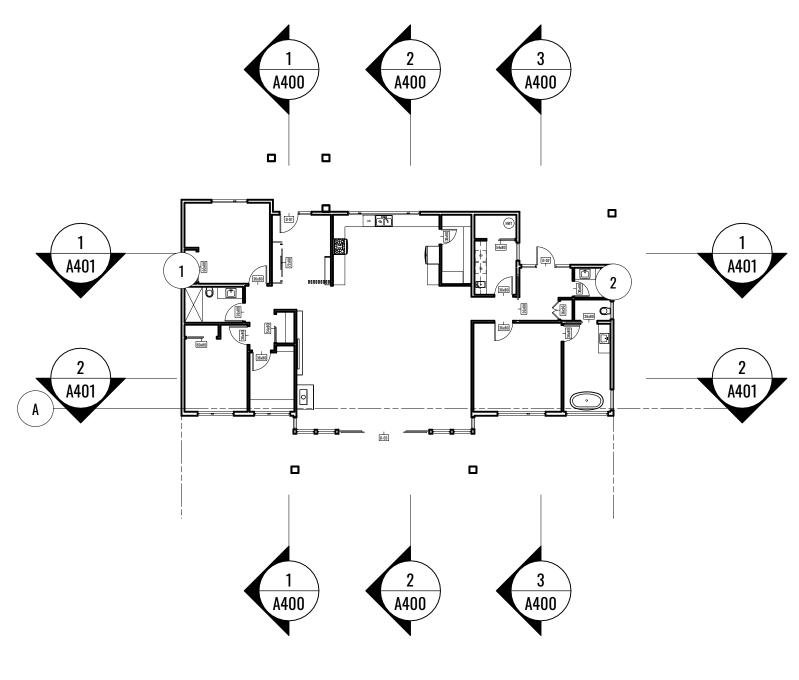

Section Key Plan
Scale: 1/16" = 1'-0"

| K | DPA | 2023-09-12 |
|---|-------------------|------------|
| J | revised | 2023-08-22 |
| 1 | revised | 2023-08-08 |
| Н | revised | 2023-07-31 |
| G | revised | 2023-07-10 |
| F | revised | 2023-06-27 |
| E | consultant review | 2023-05-05 |
| no. | issue description | date |
| convight reserved these drawings and designs are and at all times | | |

copyright reserved. these drawings and designs are and at all times remain the property of Coast + Beam Architecture to be used for the project shown and may not be reproduced without written consent.


project name

Van Mol / Freeman Residence

Highland Road
sheet title

Building Sections

| | A400 | |
|-----------|------|------------|
| sheet no. | | 7 |
| drawn by | | Amanda Hoy |
| scale | | as noted |
| date | | 2023-09-12 |
| | | |

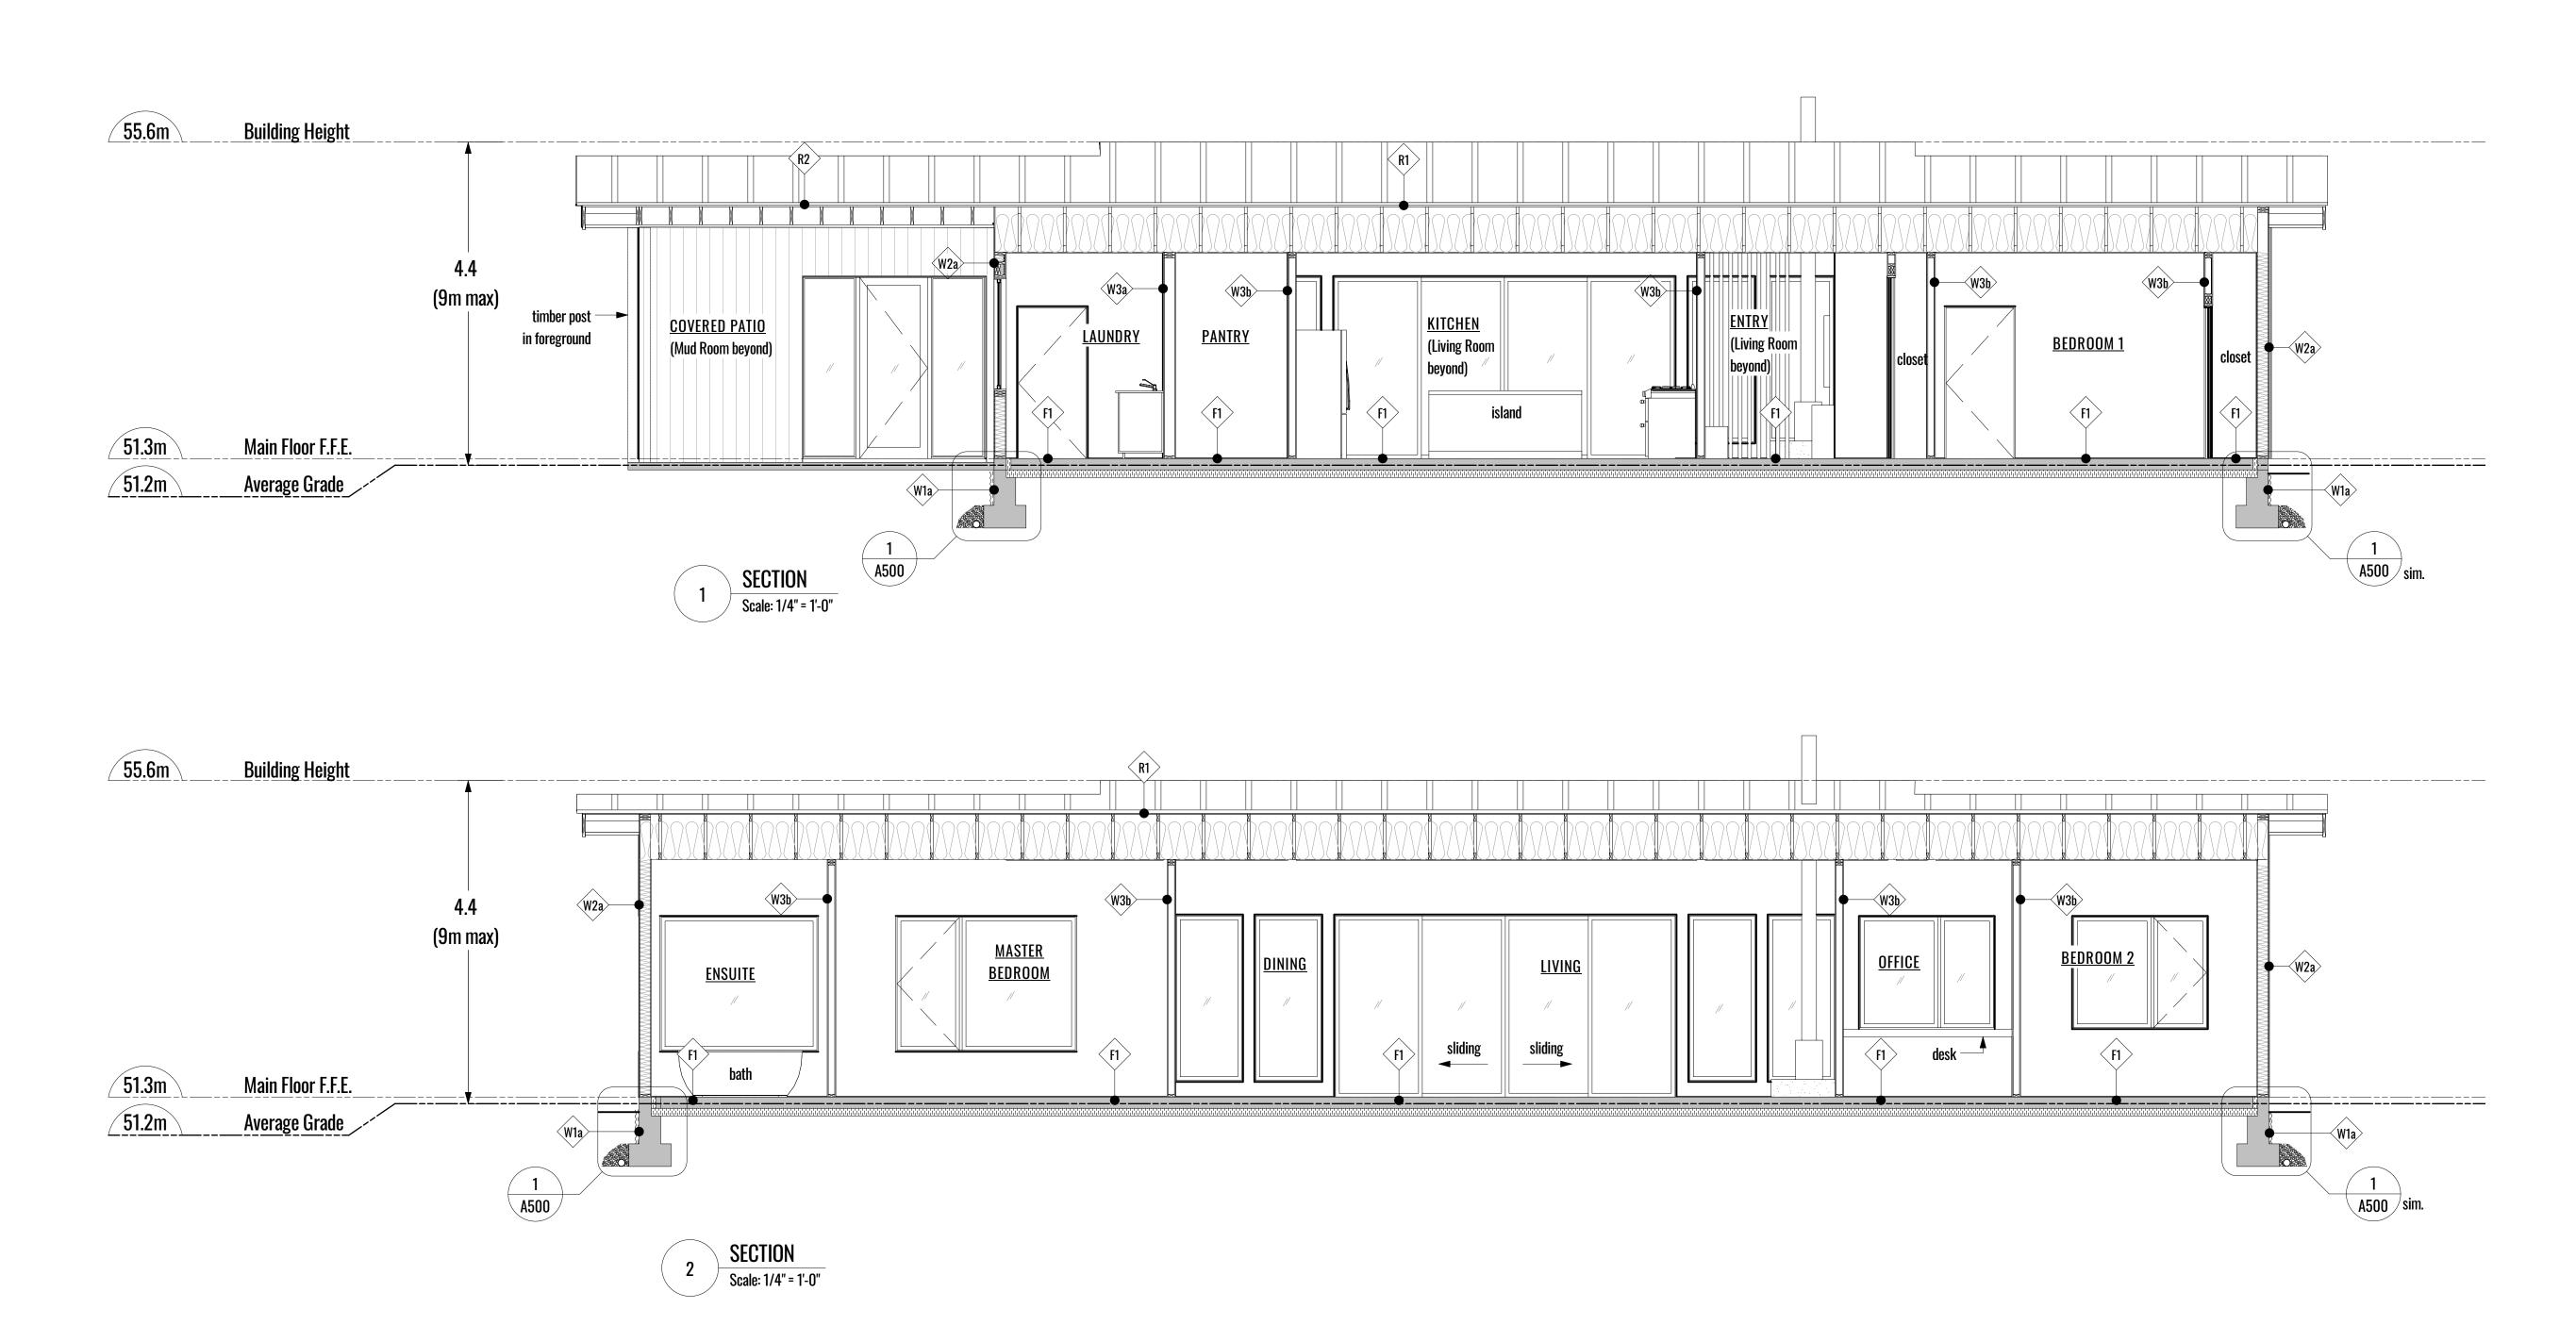




| E | consultant review | 2023-05-05 |
|---|-------------------|------------|
| F | revised | 2023-06-27 |
| G | revised | 2023-07-10 |
| Н | revised | 2023-07-31 |
| I | revised | 2023-08-08 |
| J | revised | 2023-08-22 |
| K | DPA | 2023-09-12 |
| | | |


Van Mol / Freeman Residence

Highland Road

Building Sections

2023-09-12

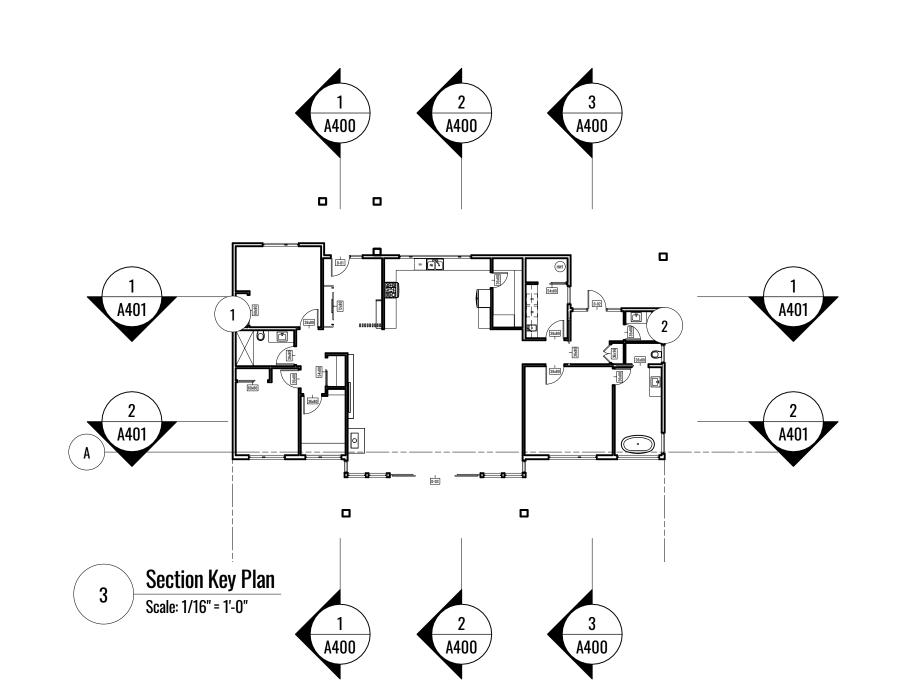

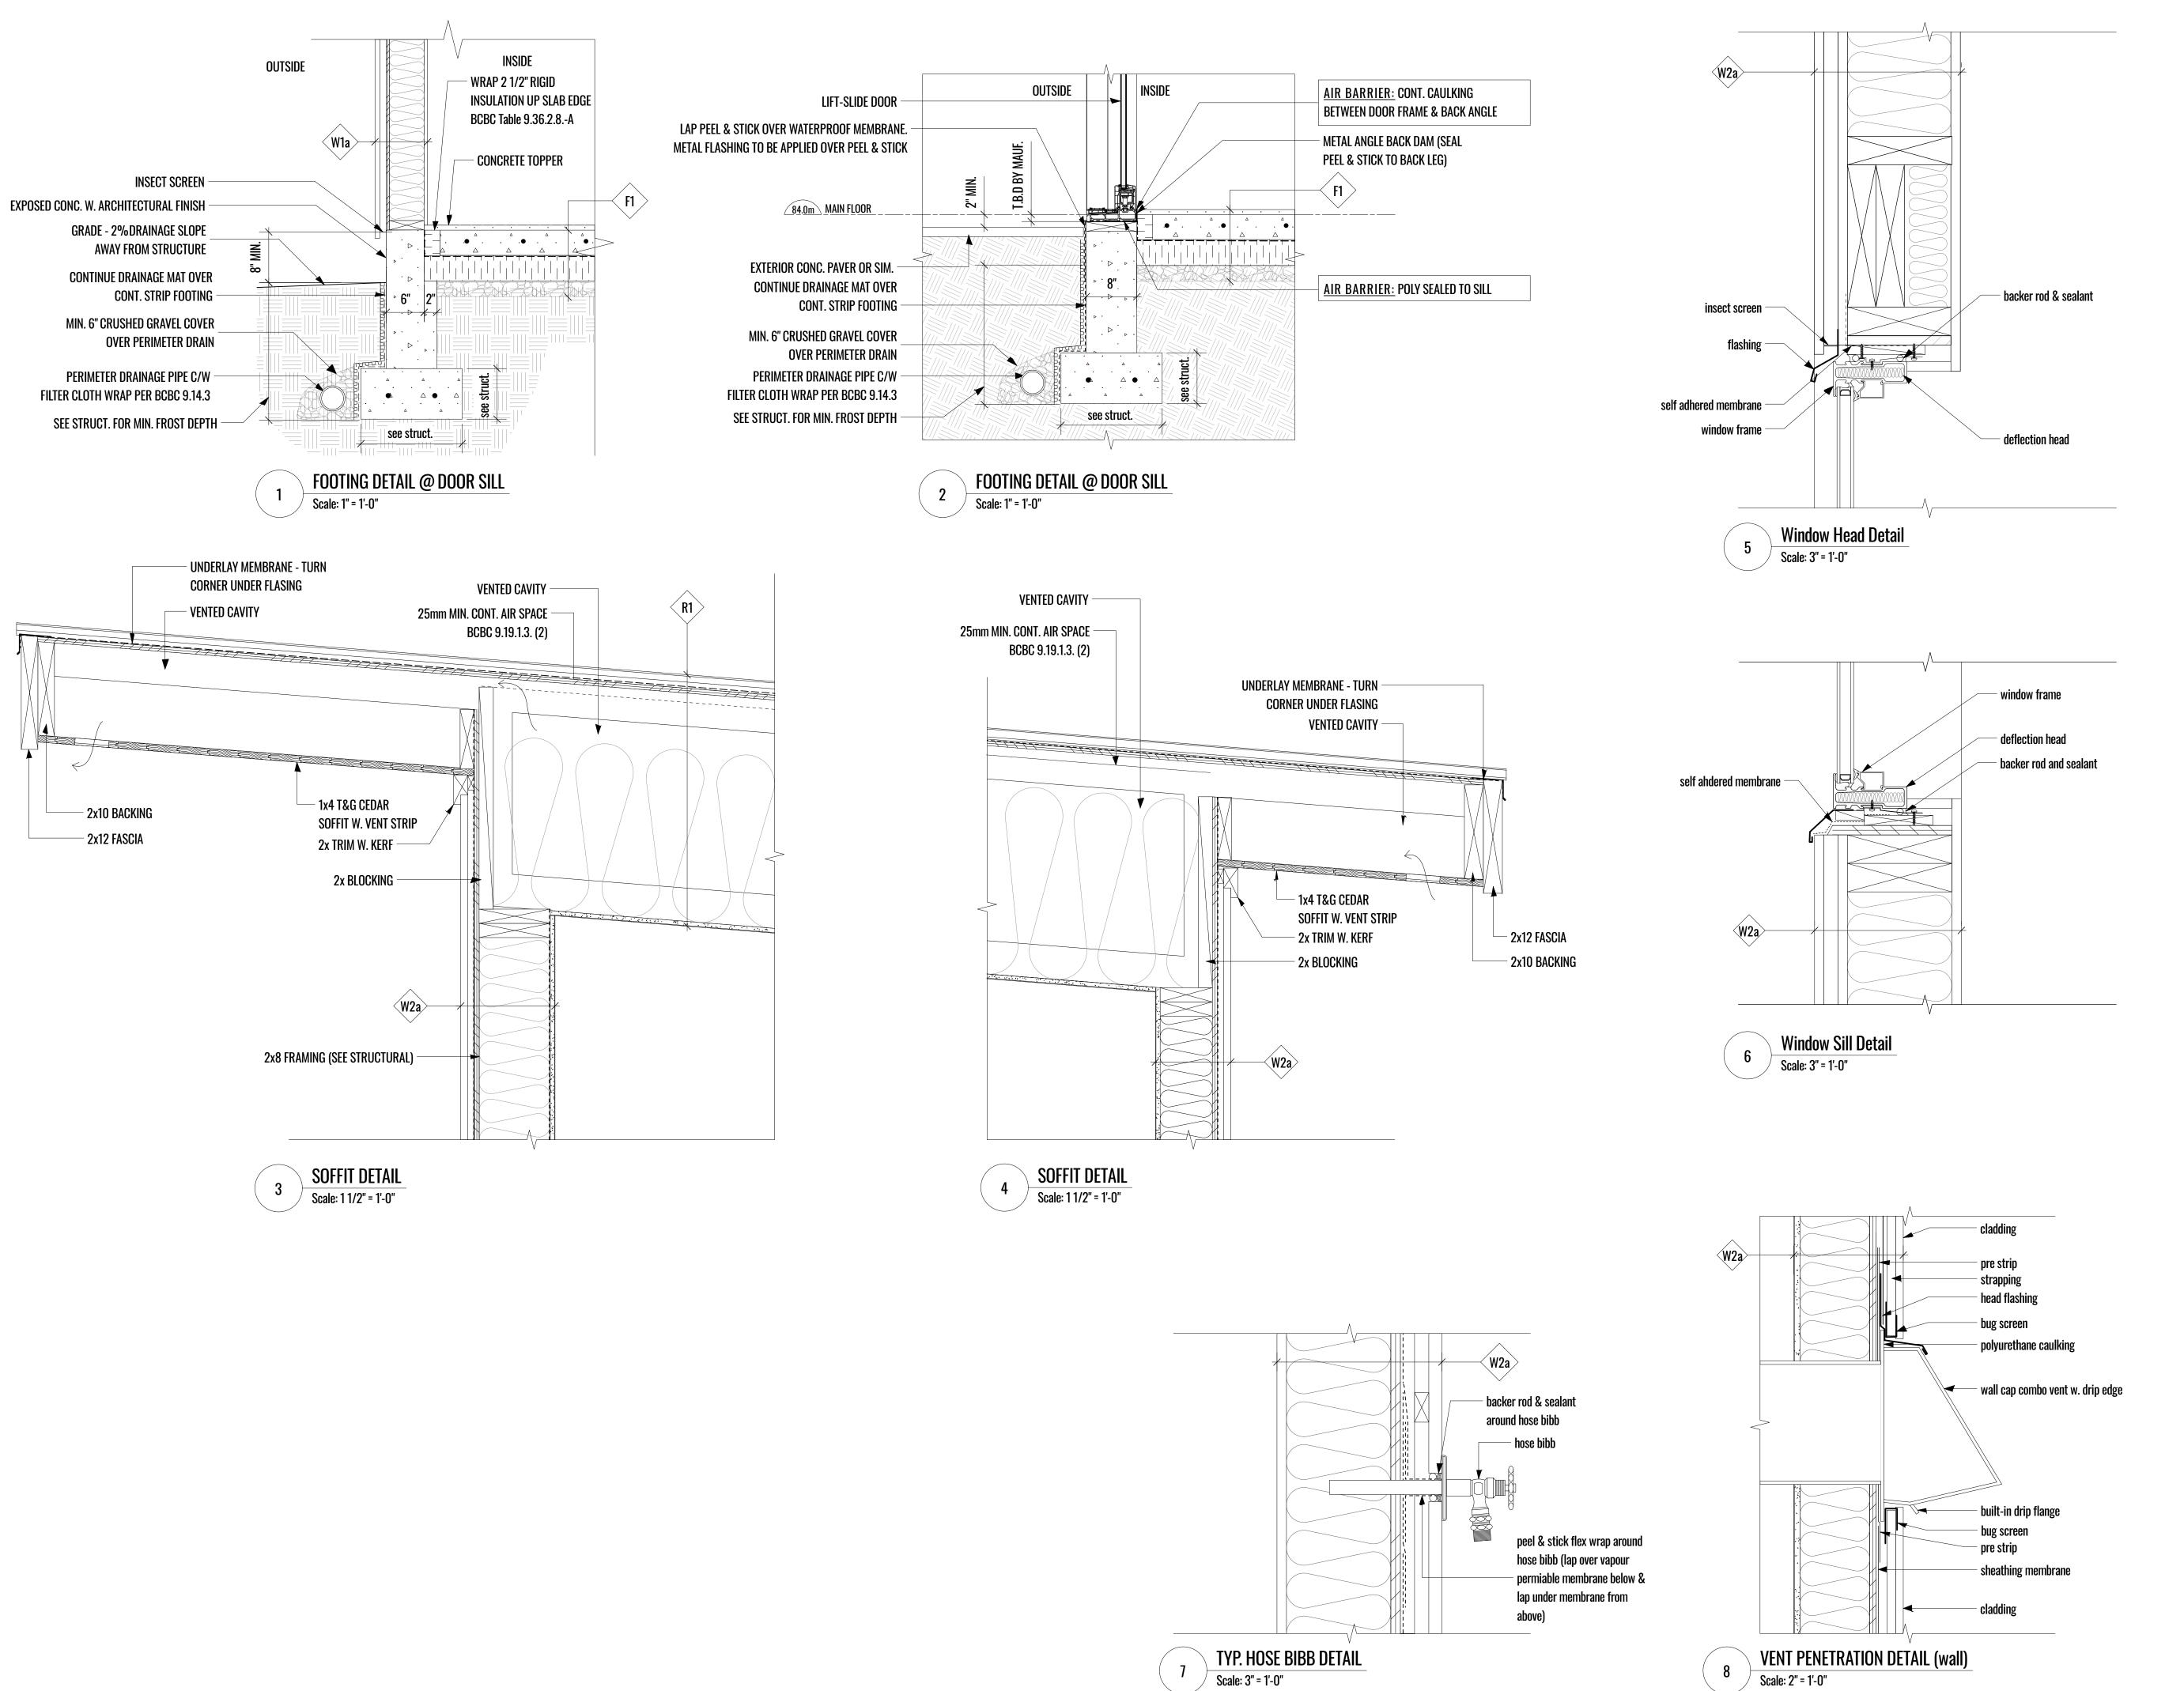



ALL RIGHTS OF WAY BOUNDARIES, SETBACKS AND PROPERTY LINES TO BE CONFIRMED BY B.C.L.S. PRIOR TO

CONTRACTOR TO VERIFY ALL DIMENSIONS AND CONFIRM

ANY INCONSISTENCIES OR UNFORESEEN CONDITIONS TO BE REVIEWED BY THE ARCHITECT PRIOR TO PROCEEDING WITH CONSTRUCTION

ALL CLEARANCES, METHODS AND MATERIALS TO BE COMPLIANT TO ALL APPLICABLE BUILDING CODES AND MUNICIPAL BYLAWS

SITE SURVEY PROVIDED BY SUMMIT LAND SURVEYING INC. ALL DIMENSIONS ARE IN FEET AND INCHES UNLESS

DO NOT SCALE DRAWINGS

OTHERWISE NOTED

ALL DIMENSIONS ARE MEASURED TO FACE OF STRUCTURE, UNLESS NOTED OTHERWISE

SMOKE ALARMS TO CONFORM WITH CAN/ULC - S531, REFER TO BCBC 2018

8 VENT PENETRATION DETAIL (wall)
Scale: 2" = 1'-0"

Details

sheet no.

Highland Road

sheet title

DPA

consultant review

copyright reserved. these drawings and designs are and at all times remain the property of Coast + Beam Architecture to be used for the project shown and may not be reproduced without written consent.

Van Mol / Freeman Residence

no. issue description

2023-09-12

2023-08-22

2023-08-08


2023-07-31


2023-07-10

2023-06-27

2023-05-05

2023-09-12 as noted drawn by Amanda Hoy

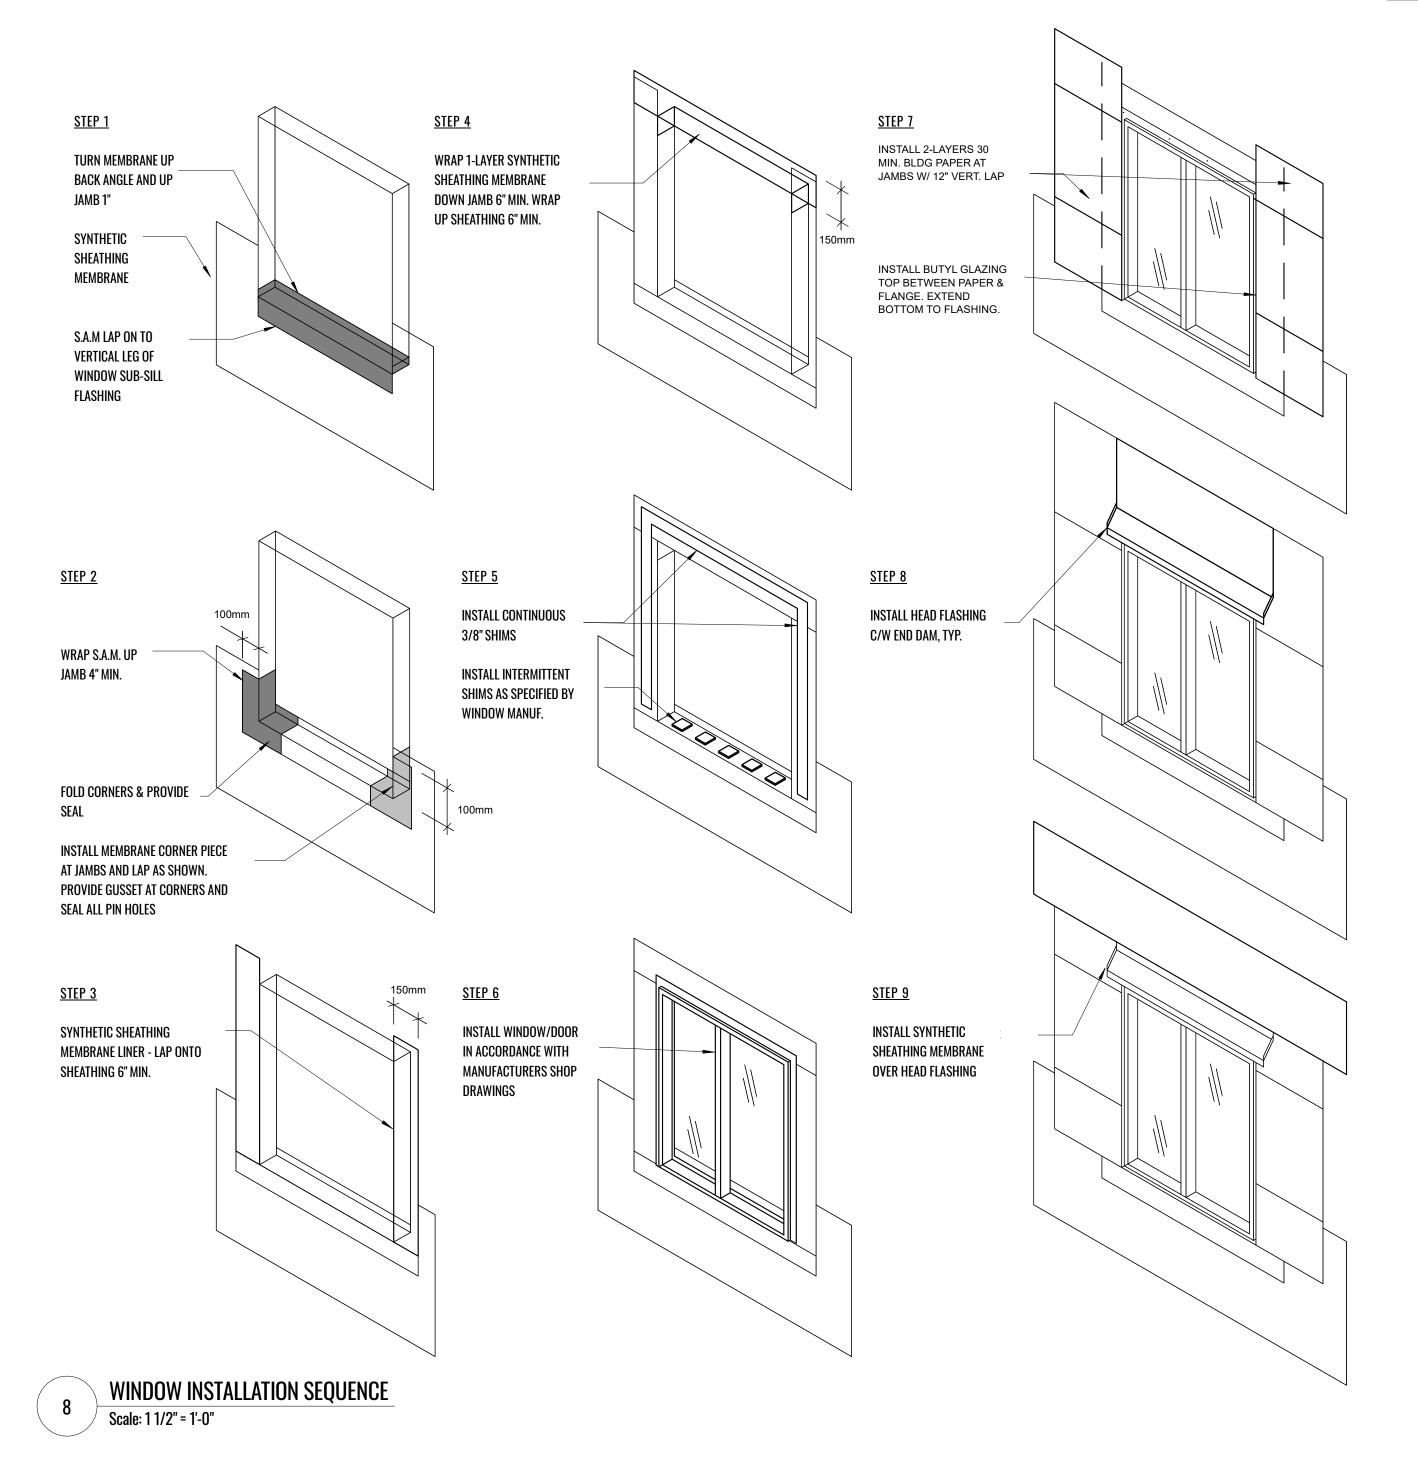

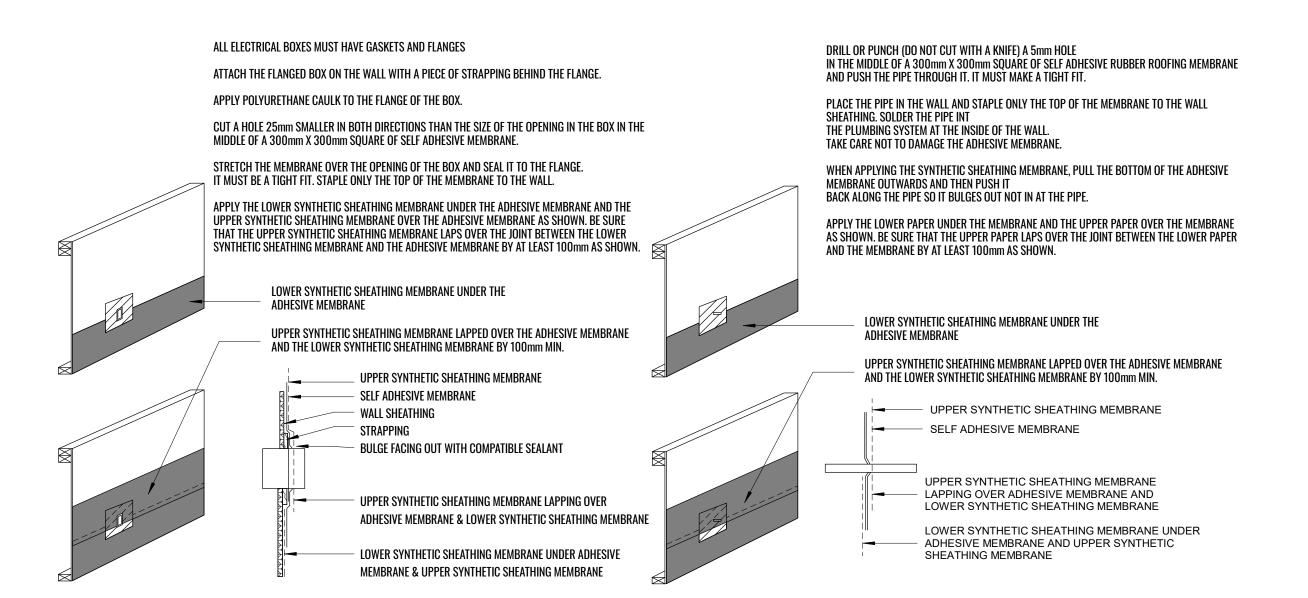

ELECTRICAL RECEPTION PENETRATION DETAIL Scale: 1 1/2" = 1'-0"





GENERAL NOTES

ALL RIGHTS OF WAY BOUNDARIES, SETBACKS AND PROPERTY LINES TO BE CONFIRMED BY B.C.L.S. PRIOR TO

CONTRACTOR TO VERIFY ALL DIMENSIONS AND CONFIRM SAME ON SITE

ANY INCONSISTENCIES OR UNFORESEEN CONDITIONS TO BE REVIEWED BY THE ARCHITECT PRIOR TO PROCEEDING WITH CONSTRUCTION

ALL CLEARANCES, METHODS AND MATERIALS TO BE COMPLIANT TO ALL APPLICABLE BUILDING CODES AND MUNICIPAL BYLAWS

SITE SURVEY PROVIDED BY SUMMIT LAND SURVEYING INC.

ALL DIMENSIONS ARE IN FEET AND INCHES UNLESS OTHERWISE NOTED

DO NOT SCALE DRAWINGS

ALL DIMENSIONS ARE MEASURED TO FACE OF STRUCTURE, UNLESS NOTED OTHERWISE

SMOKE ALARMS TO CONFORM WITH CAN/ULC - S531, REFER TO BCBC 2018

K DPA 2023-09-12 2023-08-22 2023-08-08 2023-07-31 2023-07-10 2023-06-27 2023-05-05 consultant review no. issue description copyright reserved. these drawings and designs are and at all times remain the property of Coast + Beam Architecture to be used for the project shown and may not be reproduced without written consent.


project name

Van Mol / Freeman Residence

Highland Road

Details

| date | 2023-0 |
|----------|--------|
| scale | as ı |
| drawn by | Amanda |

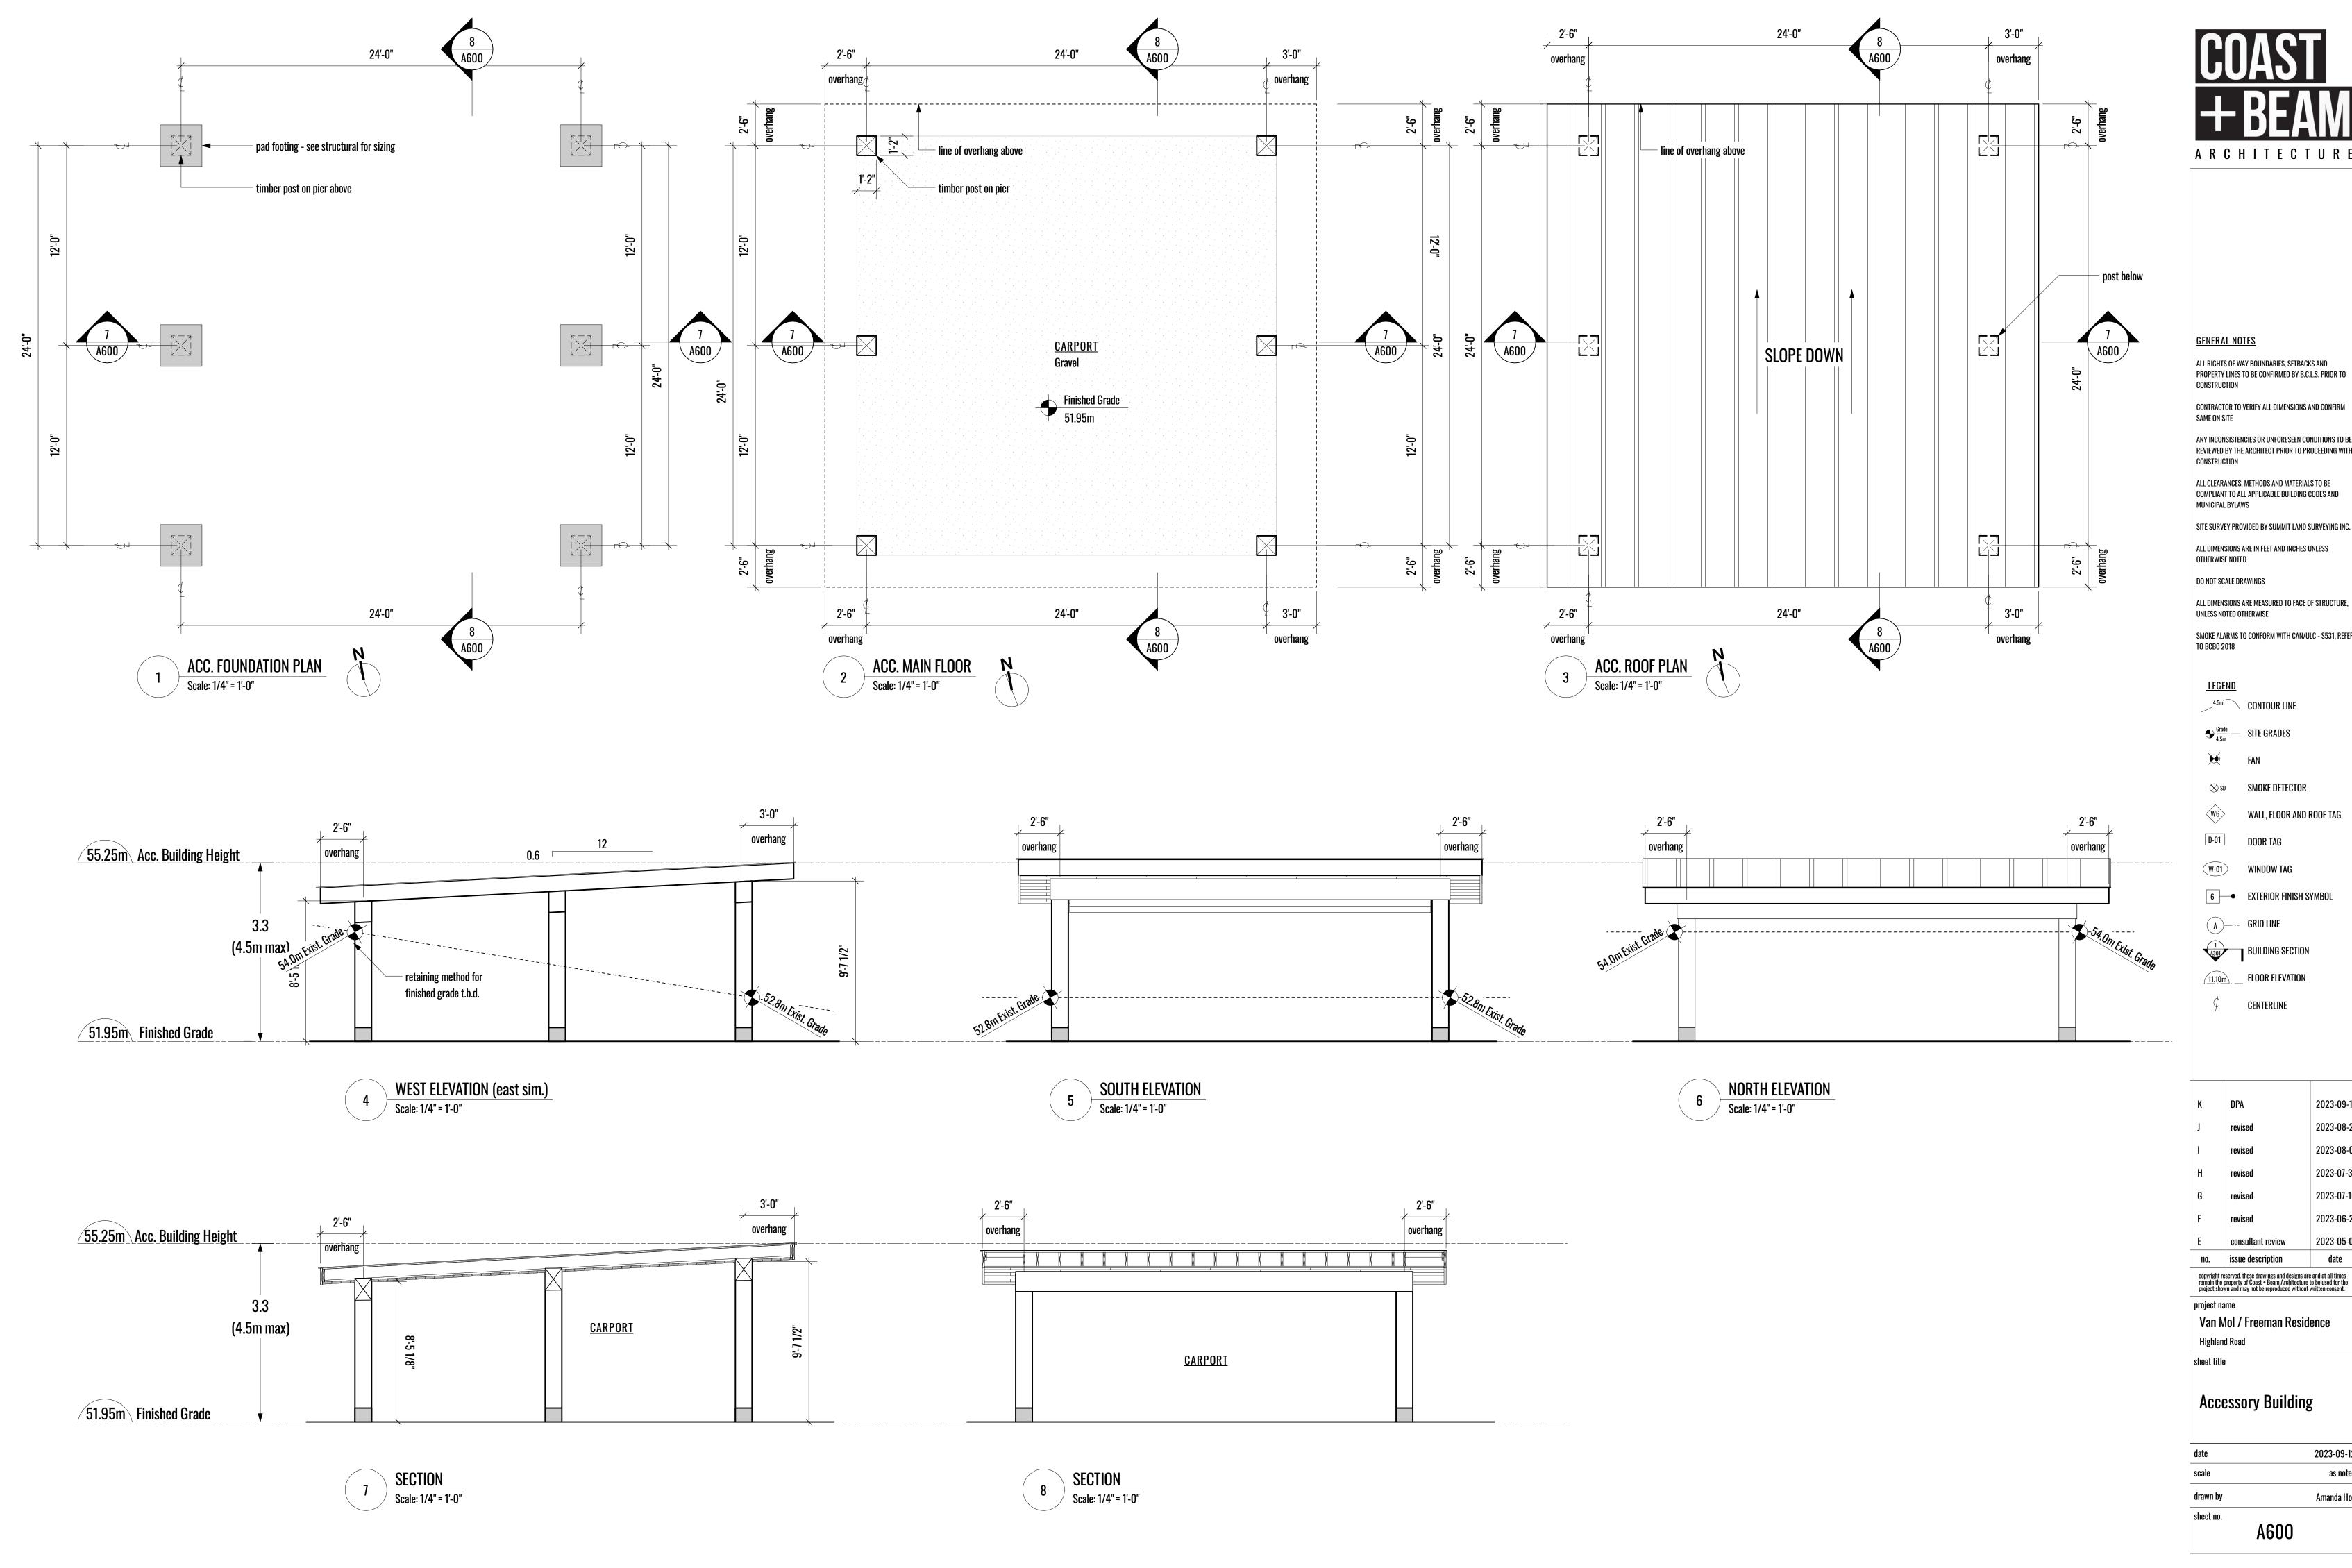



ALL RIGHTS OF WAY BOUNDARIES, SETBACKS AND PROPERTY LINES TO BE CONFIRMED BY B.C.L.S. PRIOR TO

CONTRACTOR TO VERIFY ALL DIMENSIONS AND CONFIRM

ANY INCONSISTENCIES OR UNFORESEEN CONDITIONS TO BE REVIEWED BY THE ARCHITECT PRIOR TO PROCEEDING WITH

ALL CLEARANCES, METHODS AND MATERIALS TO BE COMPLIANT TO ALL APPLICABLE BUILDING CODES AND

SITE SURVEY PROVIDED BY SUMMIT LAND SURVEYING INC.

ALL DIMENSIONS ARE MEASURED TO FACE OF STRUCTURE,

SMOKE ALARMS TO CONFORM WITH CAN/ULC - S531, REFER

WALL, FLOOR AND ROOF TAG

DOOR TAG

WINDOW TAG

BUILDING SECTION

CENTERLINE

| K | DPA | 2023-09-12 |
|------|-------------------|------------|
| J | revised | 2023-08-22 |
| ı | revised | 2023-08-08 |
| Н | revised | 2023-07-31 |
| G | revised | 2023-07-10 |
| F | revised | 2023-06-27 |
| E | consultant review | 2023-05-05 |
| 110. | issue description | date |

copyright reserved. these drawings and designs are and at all times remain the property of Coast + Beam Architecture to be used for the project shown and may not be reproduced without written consent.

Van Mol / Freeman Residence

Accessory Building

| 1.1. | 0000 00 10 |
|----------|------------|
| date | 2023-09-12 |
| scale | as noted |
| | |
| drawn by | Amanda Hoy |
| sheet no | |



EAST ELEVATION



WEST ELEVATION







COVERED ENTRY

LIVING & DINING ROOM



| K | DPA | 2023-09-1 |
|---|-------------------|------------|
| J | revised | 2023-08-2 |
| I | revised | 2023-08-0 |
| Н | revised | 2023-07-3 |
| G | revised | 2023-07-10 |
| F | revised | 2023-06-2 |
| E | consultant review | 2023-05-0 |
| no. | issue description | date |
| copyright reserved. these drawings and designs are and at all times | | |

copyright reserved. these drawings and designs are and at all times remain the property of Coast + Beam Architecture to be used for the project shown and may not be reproduced without written consent.

project name

Van Mol / Freeman Residence

Van Mol / Freeman R Highland Road

3D Model

| drawn by | Amanda |
|----------|---------|
| scale | as no |
| date | 2023-09 |
| | |